

Jackson • Biloxi

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Natchez-Adams School District ESSER 3

10 Homochitto St. Natchez, MS 39120 **DBA PN:** 21052 **Construction Documents** 11/11/2022

Superintendent

Board of Trustees President Vice President Secretary As. Secretary Member Attorney

Team Members Owner Architect Mechanical Electrical

Amos James, Jr. Phillip West Dr. Cecile Dianne Bunch Dr. Brenda Robinson LLJuna Grennell Weir Bruse Kuehnle, Jr.

Natchez Adams School District Dale | Bailey, an Association GSK Mechanical, Inc. The Power Source PLLC



Fred T. Butcher

Project Directory

Project Information

Name:	Natchez Adams School District ESSER
Project #:	21052
Address:	10 Homochitto St, Natchez, MS 39120

Client

Natchez Adams School District ESSER 10 Homochitto St, Natchez, MS 39120 (601) 445-2800 Contact: Fred T. Butcher, Superintendent of Education

Architect

Dale | Bailey, an Association One Jackson Place / Suite 250 188 East Capitol Street Jackson, MS 39201-2100 (601) 352-5411 Contact: Russ Blount (russblount@dalepartners.com)

Fire Protection, Plumbing, & Mechanical

GSK Mechanical, Inc. 201 Park Ct, Ridgeland, MS 39157 (601) 605-2930 Contact: Jason Kackley

Electrical

The Power Source, PLLC. 945 Madison Ave, Madison, MS 39110 Contact: Freddie Borganelli (fborganelli@thepowersource.us)

(jkackley@gskmech.com)

General Project Notes

Project Locations


- 1. Morgantown Elementary Cottage Home Drive, Natchez, MS 39120
- 2. McLaurin Elementary 170 Sgt Prentiss Dr., Natchez, MS 39120
- 3. Susie B. West Elementary 161 Lewis Dr, Natchez, MS 39120

Project Alternates

- 1. ADD Alternate Toilet Room Additional Finish Work 2. DED Alternate - Remove CMU work and replace with
- Toilet Partitions 3. DED Alternate - Reduce height of new Carrier Walls to partial heights as indicated

Project Phasing Requirements

1. <u>N/A</u>

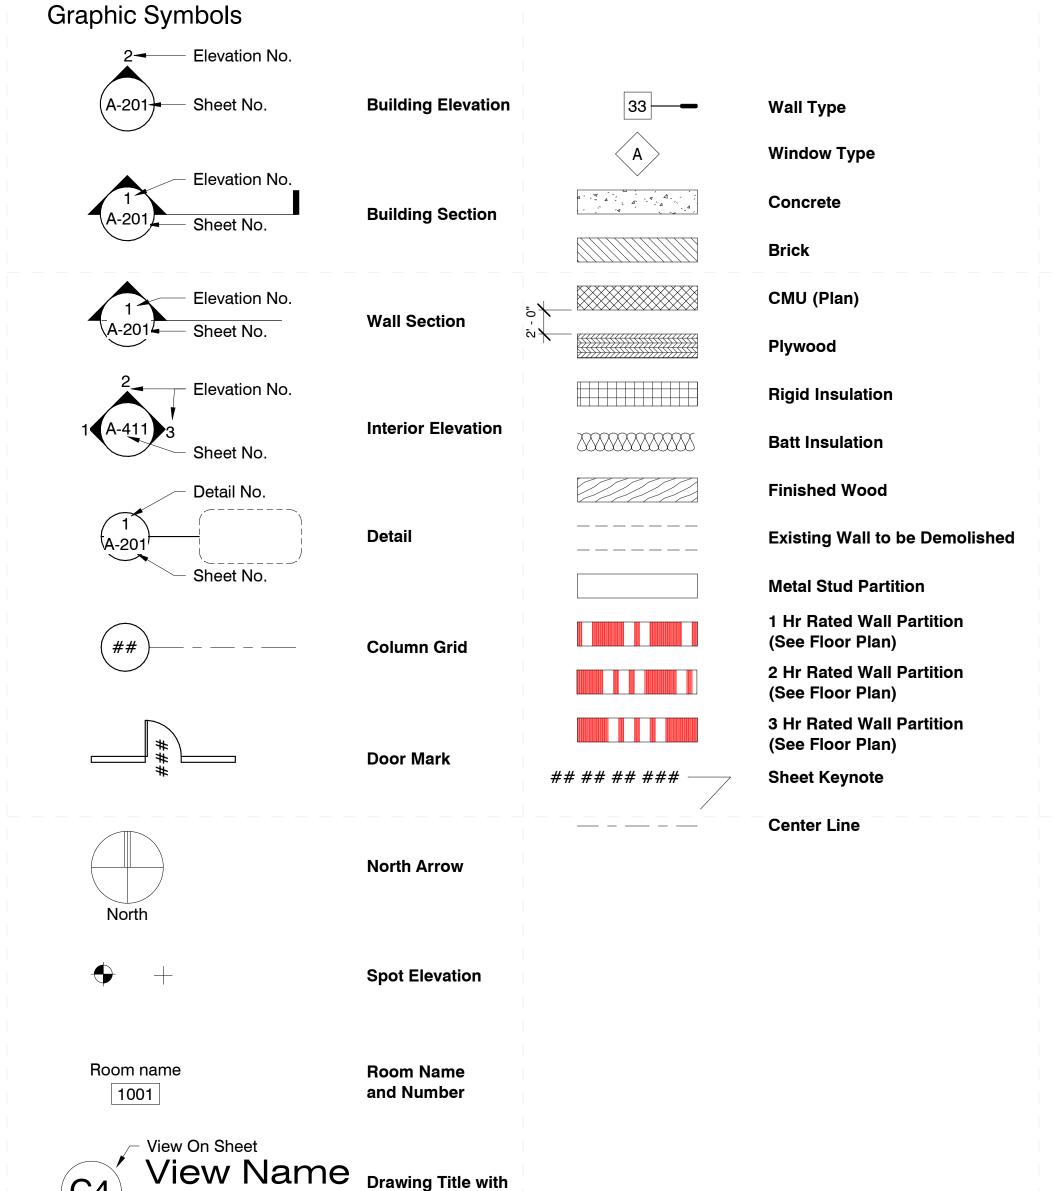

Drawing Scale

÷ ü

1-1/2" = 1'-0"

Energy Code Requirements

- 1. IBC **2021** Energy Code is the mandatory energy code
- standard for this project.
- 2. All mechanical and electrical building system installed should meet all requirements of the energy code.

Thermal Envelope Requirements

- 1. Roofs = R-20 ci (insulation entirely above deck)
- 2. Walls = R-7.6ci (mass walls) 3. Walls = R-13 + R-7.5ci (metal framed walls)
- 4. Below Grade Walls = no requirement
- 5. Slab on Grade = no requirement

Fenestration Requirements (U-factor)

1.	Fixed	= U-Factor 0.46
2.	Operable	= U-Factor 0.60
3.	Entrances	= U-Factor 0.77

		•
4.	SHGC	= U-Factor 0.25

General Information

- 1. Do not scale drawings. If dimensions are in question, the contractor shall be responsible for obtaining clarification from the architect before continuing with the construction
- 2. Contractors shall verify, on the site, all dimensions and equipment locations, and notify architect
- promptly in writing of any discrepancies 3. Contractors shall be responsible to determine the on site conditions and perform all necessary work to
- complete the project 4. Contractors shall maintain safe methods of egress for occupied buildings and in site area during
- construction
- 5. All casework dimensions shall be field verified before unit fabrication or installation
- 6. Dimensions, notes, finishes, and fixtures shown on typical floor plans shall apply to similar, symmetrical, or opposite hand plans, sections, or details
- 7. Typical, or typ., shall mean that condition is representative for similar conditions throughout, U.N.O. Details are usually keyed and noted "Typ." only one time when they first occur
- 8. Partitions are dimensioned from finish face U.N.O. Dimensions to masonry are to actual finish face U.N.O.
- 9. Owner to have right of refusal for all materials, furniture, fixtures and good within the limits of the construction contract.

Drawing Index		
Sheet No	Sheet Name	Building Name
G-001 Cover Sheet		General
G-002 Index & General Project	ct Information	General
G-000a General Sheet		A: Morgantown Elementary
A-101a Morgantown Elementa	ary	A: Morgantown Elementary
A-401a Enlarged Bathroom Pla	ans	A: Morgantown Elementary
A-402a Enlarged Bathroom Pla	ans	A: Morgantown Elementary
G-000b General Sheet		B: McLaurin Elementary
A-101b McLaurin Elementary S	School Composite Floor Plan	B: McLaurin Elementary
G-000c General Sheet		C: Susie B. West Elementary
A-101c Susie B. West Element	-	C: Susie B. West Elementary
A-401c Enlarged Bathroom Pla		C: Susie B. West Elementary
A-402c Enlarged Bathroom Pla	ans	C: Susie B. West Elementary
M-000 General Mechanical In	formation	General
M-001a Overall New HVAC Wo		A: Morgantown Elementary
M-101a Partial New HVAC Wor M-102a Partial New HVAC Wor		A: Morgantown Elementary A: Morgantown Elementary
M-103a Partial New HVAC Wor		A: Morgantown Elementary
M-104a Partial New HVAC Wor		A: Morgantown Elementary
M-105a Partial New HVAC Wor	rk	A: Morgantown Elementary
M-201a Enlarged Toilet Plans		A: Morgantown Elementary
M-202a Enlarged Toilet Plans		A: Morgantown Elementary
M-203a Enlarged Toilet Plans MD001a Overall Mechanical De		A: Morgantown Elementary A: Morgantown Elementary
M-001b Overall New HVAC Wo		B: McLaurin Elementary
M-002b Overall New HVAC Wo		B: McLaurin Elementary
M-101b Partial New HVAC Wor		B: McLaurin Elementary
M-102b Partial New HVAC Wor		B: McLaurin Elementary
M-103b Partial New HVAC Wor		B: McLaurin Elementary
M-104b Partial New HVAC Wor M-105b Partial New HVAC Wor		B: McLaurin Elementary
MD001b Overall Mechanical De		B: McLaurin Elementary B: McLaurin Elementary
MD002b Overall Mechanical De		B: McLaurin Elementary


E-XXX Electrical Sheets

Electrical Sheets

General Abbreviations

AC	AIR CONDITIONING	EA	EACH	HGT	HEIGHT
ABV	ABOVE	EDF	ELECTRIC DRINKING FOUNTAIN	HM	HOLLOW METAL
ACT	ACOUSTICAL CEILING TILE	EHD	ELECTRIC HAND DRYER	HOW	HORIZONTAL
ADJ	ADJUSTABLE	EIFS	EXTERIOR INSULATING FINISH SYSTEM	HR	HAND RAIL
AFF	ABOVE FINISH FLOOR	EJ	EXPANSION JOINT	HTG	HEATING
ALT	ALTERNATE	ELEC	ELECTRICAL	HVAC	HEATING/VENTILATION/AIR CONDITIONING
	ALUMINUM	ELEV	ELEVEATION	HYD	HYDRANT
	ANODIZED	ELVR	ELEVATOR	ID	INSIDE DIAMETER
APRX	APPROXIMATE	EQ	EQUAL	INSUL	INSULATION
AFITA	AUDIO VISUAL	EW	EQUAL EACH WAY	INT	INTERIOR
AVD	AUDIO VISUAL DISPLAY	EWF	ENGINEERED WOOD FLOORING	INV	INVERT
BD	BOARD	EXH	EXHUAST		JANITOR
BLDG				JAN JC	JENITORS CLOSET
	BUILDING	EXIST	EXISTING		
BLKG		EXP	EXPANSION	JST	JOIST
BOC	BOTTOM OF CURB	EXT		JT	
BOS	BOTTOM OF STEEL	FCF	FINISHED CONCRETE FLOOR	KD	
BW	BOTH WAYS	FCO	FLOOR CLEAN OUT	KIT	KITCHEN
CAB	CABINET	FD		KO	KNOCK OUT
CB		FE	FIRE EXTINGUISHER	KPL	KICKPLATE
CC	CENTER TO CENTER	FEC	FIRE EXTINGUISHER CABINET	L	LENGTH
CCT	CONCRETE COUNTER TOP	FFE	FINISH FLOOR ELEVATION	LAB	LABORATORY
CG	CORNER GUARD	FIN	FINISH	LAD	LADDER
CH	COAT/CLOTHES HOOK	FLG	FLOORING	LAM —	LAMINATE
CHM	CHAMFER	FLOR	FLOURESCENT	LAV	LAVATORY
CJ	CONTROL JOINT	FLR	FLOOR	LAWP	LIQUID APPLIED WATER PROOFING
CLG	CEILING	FND	FEMININE NAPKIN DISPENSER	LBL	LABEL
CLO	CLOSET	FOF	FACE OF FINISH	LF	LINEAR FEET
CMU	CONCRETE MASONRY UNIT	FOM	FACE OF MASONRY	LH	LEFT HAND
CO	CLEAN OUT	FOS	FACE OF STUD	LIN	LINOLEUM
COL	COLUMN	FP	FIRE PROOF	LL	LIVE LOAD
CONC	CONCRETE	FRP	FIBERGLASS REINFORCED PANEL	LPP	LAVATORY PIPING PROTECTION
CONT	CONTINUOUS	FRT	FIRE RETARDENT	LT	LIGHT
CORR	CORRIDOR	FT	FOOT/FEET	LTG	LIGHTING
CPT	CARPET	FTG	FOOTING	LVT	LUXURY VINYL TILE
CR	CRASH RAIL	FWC	FABRIC WALLCOVERING	LWC	LIGHTWEIGHT CONCRETE
CT	CERAMIC TILE	G	GAS	MAS	MASONRY
CTR	CENTERED	GA	GAUGE	MAX	MAXIMUM
CYP	CYPRESS	GB	GRAB BAR	MB	MARKER BOARD
DBH	DISPOSAL BAG HOLDER	GC	GENERAL CONTRACTOR	MC	MEDICINE CABINET
DBL	DOUBLE	GCT	GRANITE COUNTER TOP	MCT	MARBLE COUNTER TOP
DET	DETAIL	GL	GLASS/GLAZING	MECH	MECHANICAL
DF	DRINKING FOUNTAIN	GT	GRANITE TILE	MFG	MANUFACTURER/MANUFACTURED
DIA	DIAMETER	GWB	GYPSUM DRYWALL	MG	MEDICAL GAS
DIAG	DIAGONAL	GYP	GYPSUM	MIN	MINIMUM
DIM	DIMENSION	HB	HOSE BIB	MIR	MIRROR
DISP	DISPENSER	HC	HOLLOW CORE	MISC	MISCELLANEOUS
DN	DOWN	HD	HEAVY DUTY	MLDG	MOULDING
DRW	DECAY RESISTANT WOOD	HDR	HEADER	МО	MASONRY OPENING
Е	EAST	HDW	HARDWARE	MR	MOP RACK

MT MTL MWK NAT NIC NOM NRC NTS O A OCEW O OFCI OPP PAR PBD PCF PLAM PLST PLWD PMR PMS PRT PSSI PTD PTN PTN RT RT RT RT RT RT RT RT RT RT RT RT RT	METAL THRESHOLD METAL MILLWORK NORTH NATURAL NOT IN CONTRACT NUMBER NOMINAL NOISE REDUCTION COEFFICIENT NOT TO EXCEED NOT TO EXCEED NOT TO SCALE OXYGEN OUTSIDE AIR ON CENTER ON CENTER ON CENTER EACH WAY OUTSIDE DIAMETER OWNER FURNISHED / CONTRACTOR INSTALLED OPENING OPPOSITE PAINT/PAINTED PARALLEL PARTICLE BOARD PRESSED/PATTERNED CONCRETE FLOOR PLASTIC COUNTER TOP PERFORATED PLATE PLASTIC LAMINATE PLASTIC LAMINATE PLASTER PLYWOOD PREFORMED METAL SIDING PAIR PORCELAIN CERAMIC TILE POUNDS PER SQUARE FOOT POUNDS PER SQUARE FOOT POUNDS PER SQUARE INCH PRESSURE TREATED PAPER TOWEL RECPTACLE QUARTZ RESINOUS FLOORING QUARRY TILE QUARTER RISER RADIUS RUBBER BASE RUBBER REINFORCED CONCRETE PIPE ROOF DRAIN REFERENCE	REFR REQ REV RM RND ROW RPS RS SCD SCF SD SCF SD SCC SCCF SD SCC SCCF SD SCC SCCF SD SCC SCCF SD SCC SCCF SD SCC SCCF SD SCC SCCF SCC SCCF SCC SCC SCCF SCC SCC	REFRIDGERATOR REINFORCED REQUIRED REVISED RIGHT HAND ROUND ROUHG OPENING RIGHT OF WAY ROOF PAVER SYSTEM RETURN REGISTER SOUTH SOLID CORE SEAT COVER DISPENSER STAINED/SEALED CONCRETE FLOOR SCHEDULE SOAP DISPENSER SECTION SHEET SHEATHING SIMILAR SCORE JOINT SEAMLESS LIQUID WALL COVERING SANITARY NAPKIN DISPENSER SANITARY NAPKIN DISPENSER SANITARY NAPKIN DISPENSER SANITARY NAPKIN DISPENSER SOUNDPROOF SPACER SPECIFICATIONS SPECIMEN PASS THRU CABINET SQUARE SANITARY SEWER SHOWER SOAP DISPENSER STAINLESS STELL SOUND TRANSMISSION COEFFICIENT STANDARD STEEL STORAGE SUPPLEMENTAL SHEET VINYL SERVICE SINK SHOWER SHOWER CURTAIN SOUTHERN YELLOW PINE TREAD TOP & BOTTOM TONGUE & GROOVE TOWEL BAR TO BE DETERMINED	TBR TEL TEMP TH THK TLT TME TOC TOS TPD TPH TR TV TYP UC UNO VB VD VCB VCT VIF VT VT VT VT VT VT VT VT VT VT VT VT VT	TO BE REMOVI TELEPHONE TEMPORARY THRESHOLD THICK/THICKN TOILET TO MATCH EXI TOP OF CURB TOP OF STEEL TOILET PAPER TOILET PAPER TRANSOM TELEVISION TYPICAL UNDERCOUNT UNLESS NOTE VAPOR BARRIE VISUAL DISPLA VISUAL DISPLA VISUAL COMM VINYL COMPOS VERIFY IN FIEL VINYL TILE VENT THROUG VINYL WALL CO WEST WITH WOOD BASE WATER CLOSE WOOD COUNT WOOD BASE WIDTH WINDOW WALL GUARD WATER HEATE WATER PROOF WATER RESIST WAINSCOT
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Index & General Project Information

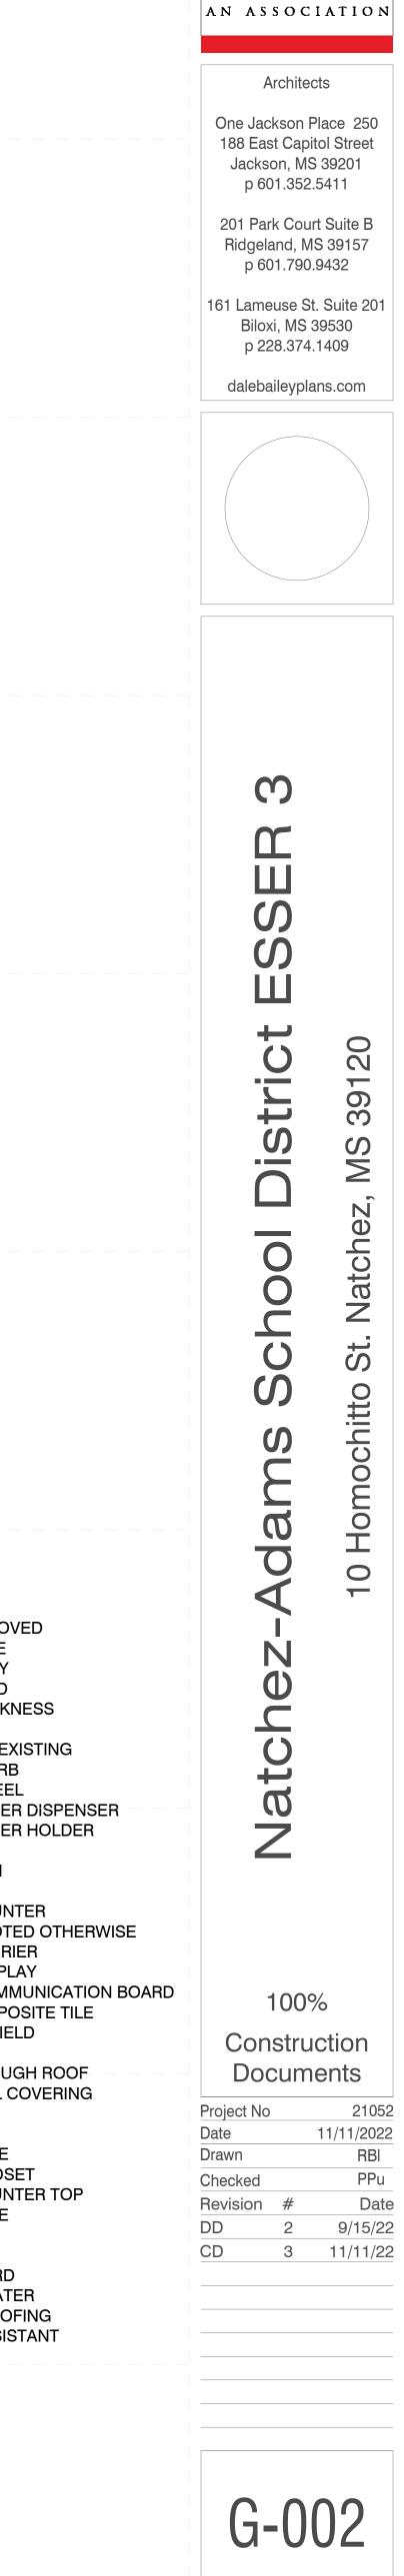All Cabaalla Craaifia Nate

08 43 00 001 08 43 00 005	Install new storefront frame and glazing No Vertical Mullions at Exterior Storefront (typical)
08 43 00 005 08 43 00 006	Required egress window in storefront
09 24 23 001	New stucco over metal lathe; provide drainage
09 24 23 002	plane membrane behind lathe; paint stucco Stucco reveal; reveals straight; edges shall not be
	rounded over but make crisp corners
09 24 23 003	Maintain same stucco detail between beams above window
22 42 00 002	New fixtures in this toilet room; coordinate with mechanical
22 42 00 003	New touchless faucet at sink/cabinet; coordinate with mechanical
22 42 00 010	New fixtures cafeteria toilet room; also new touchless fixture on hand wash sink; coordinate
22 47 13 002	with mechanical Install single drinking fountain here with bottle filler
, 10 002	attachment; coordinate with mechanical & electrical drawings
	


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General Project Notes

- 1. Whereever fixture indicated to be replaced, include new finish plumbing and standard accessories including pipe insulation, faucets, flush valves, sealant, etc.
- 2. Notify Architect in writing of any rough in plumbing that is
- not draining properly or supplying water as needed. 3. Accessories to be replaced only as noted on floor plans.




Front of School



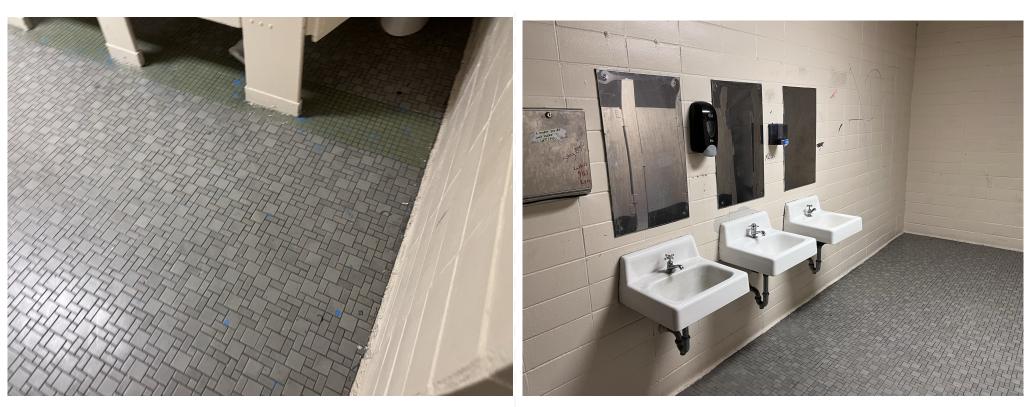

Other Cabinet Lavs



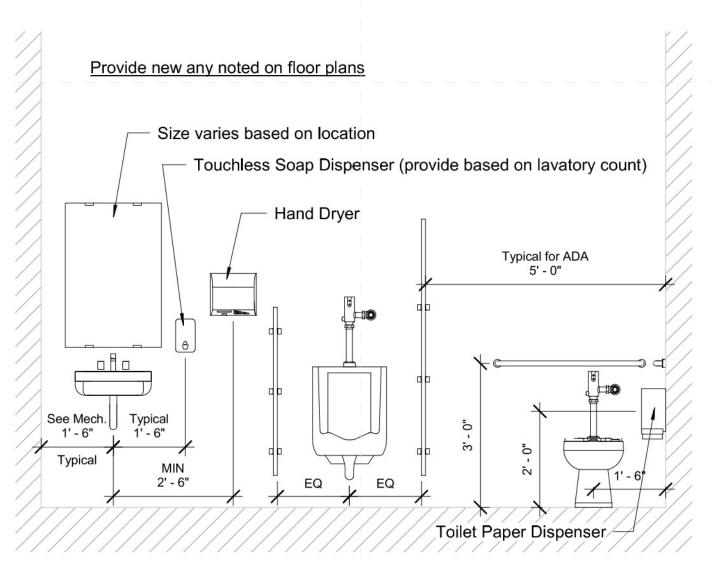

1 Typical Toilet Room Wall 1/2" = 1'-0"

Typical Toilet Rm Flr

Typical Toilet Lav Wall



Typical Urinal Style

Typical Toilet Style

Typical Class Sink




Architects

One Jackson Place 250 188 East Capitol Street Jackson, MS 39201 p 601.352.5411

201 Park Court Suite B Ridgeland, MS 39157 p 601.790.9432

161 Lameuse St. Suite 201 Biloxi, MS 39530 p 228.374.1409

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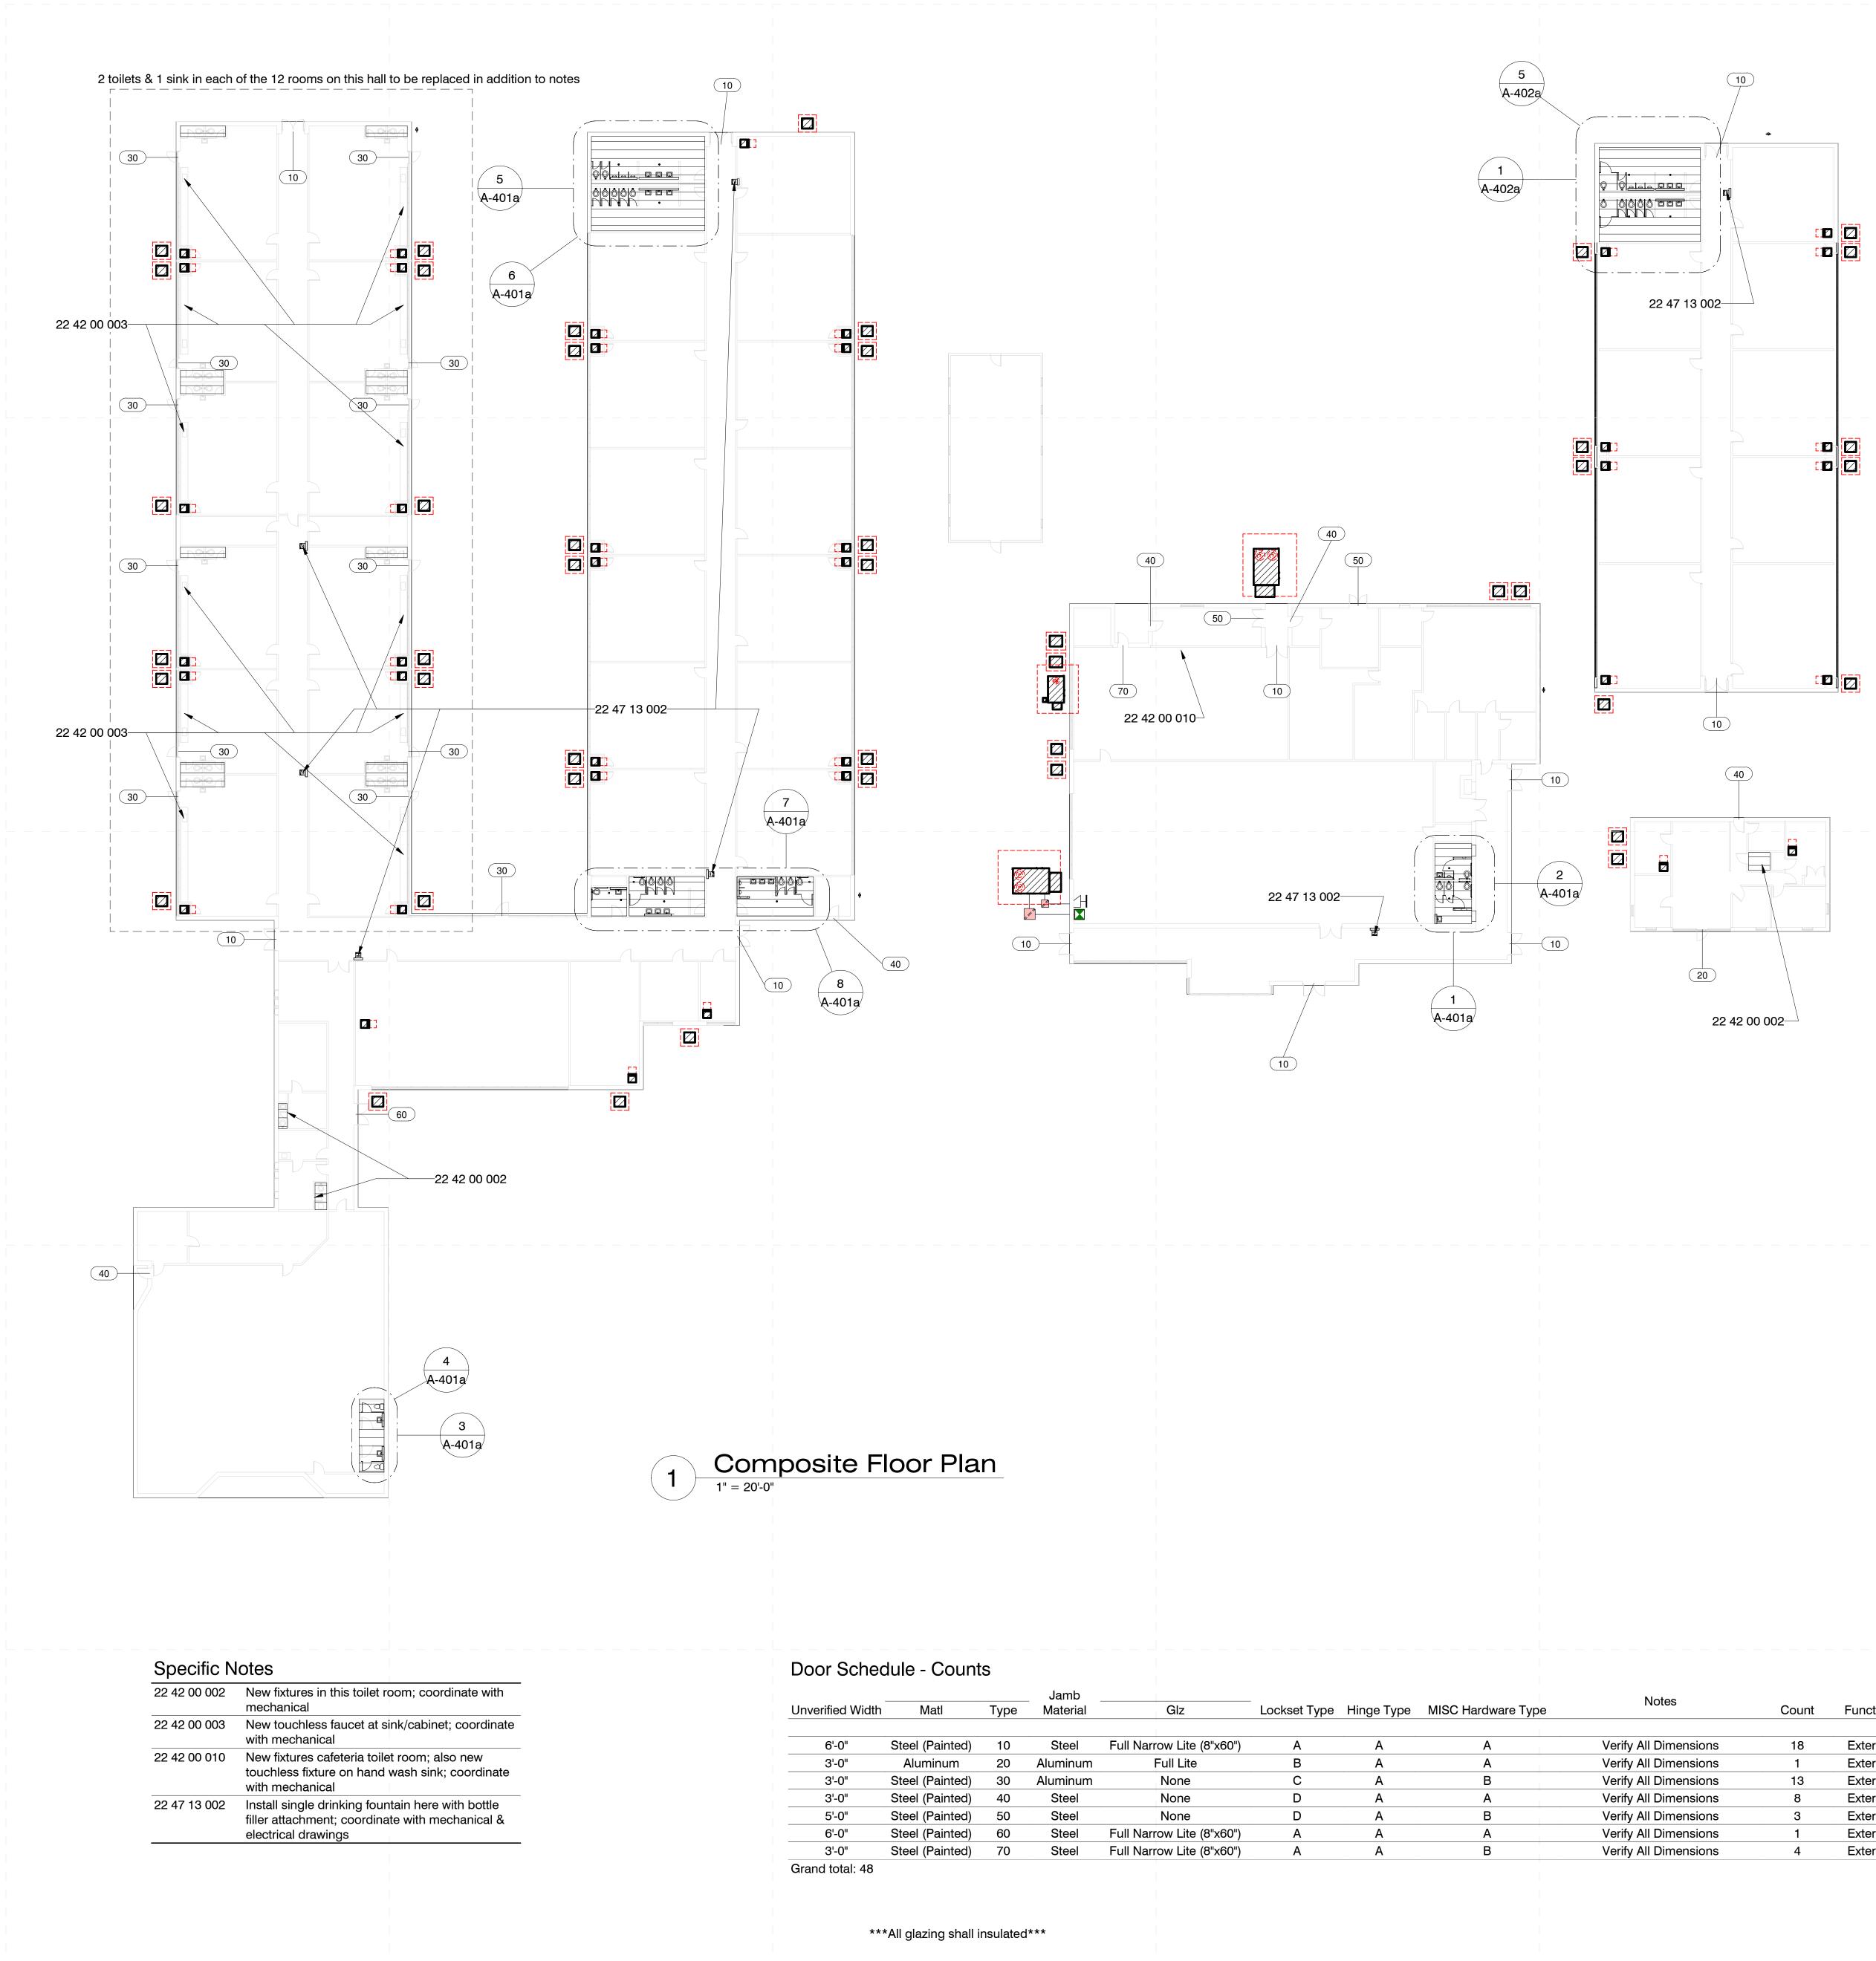


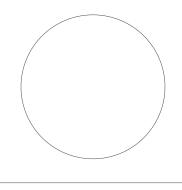3 ESSER MS 39120 Ń District Drive, Natche Cottage Home School dams Elementary: (Morgantown F Natchez 100% Construction Documents 21052 Nov. 11, 2022 PPu Project No Date Drawn RBI Checked Date Revision # 1 7/14/22 SD DD 2 9/15/22




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CD



11/10/2 C:\Usel

Repair all steel jambs with exterior rated putty compound

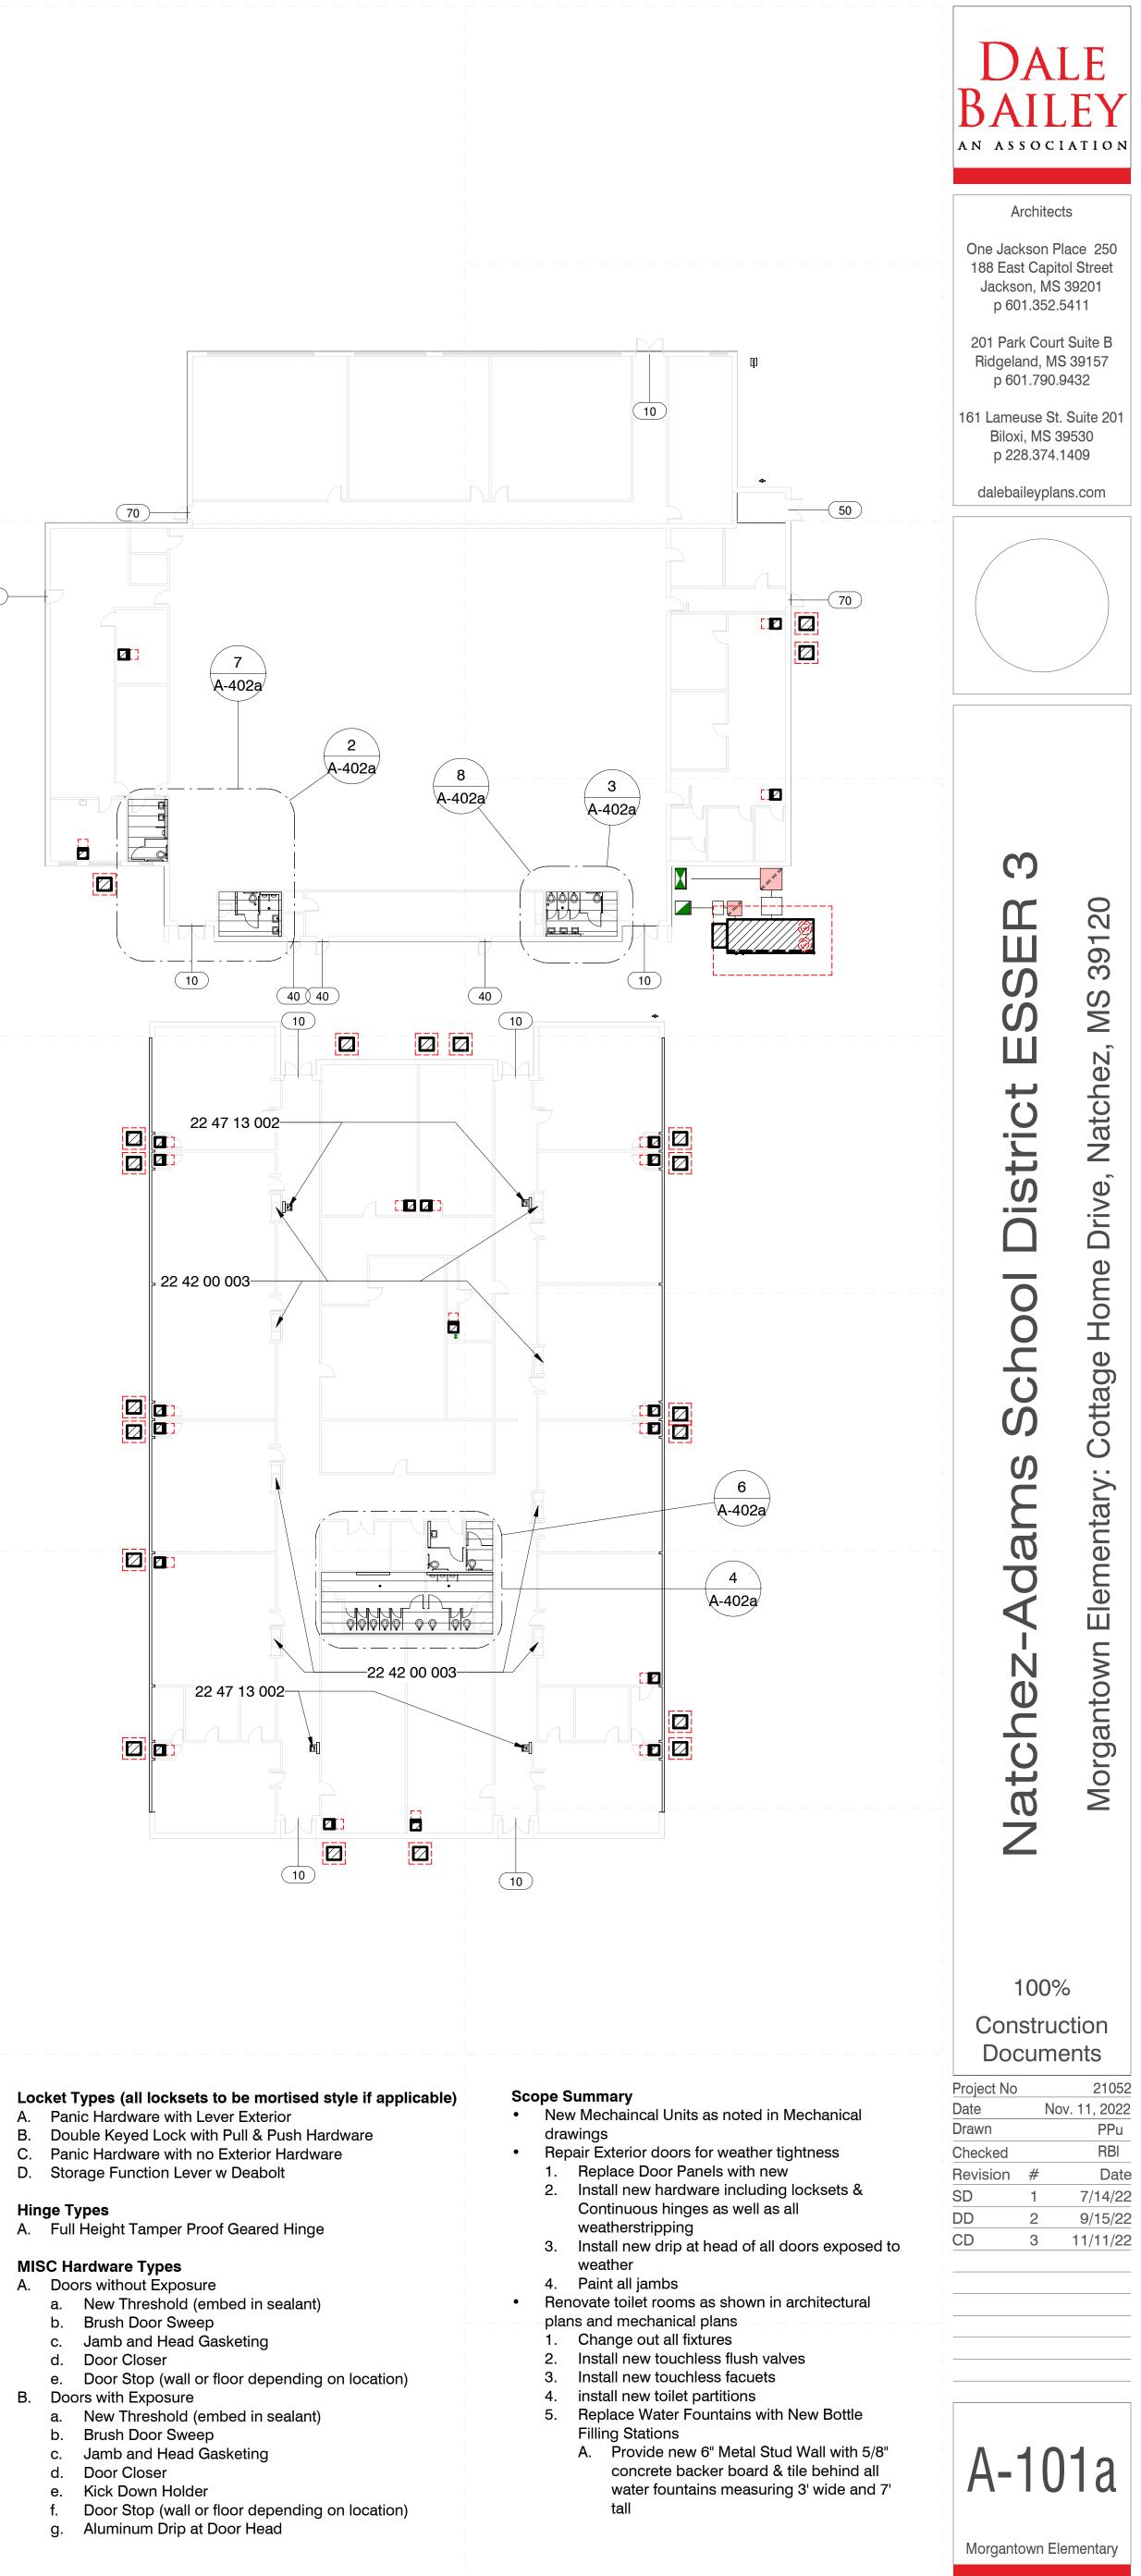

tes	Count	Function
imensions	18	Exterior
imensions	1	Exterior
imensions	13	Exterior
imensions	8	Exterior
imensions	3	Exterior
imensions	1	Exterior
imensions	4	Exterior

A. Panic Hardware with Lever Exterior

- C. Panic Hardware with no Exterior Hardware
- D. Storage Function Lever w Deabolt


Hinge Types


MISC Hardware Types

70

- A. Doors without Exposure
- c. Jamb and Head Gasketing
- d. Door Closer

- b. Brush Door Sweep
- d. Door Closer

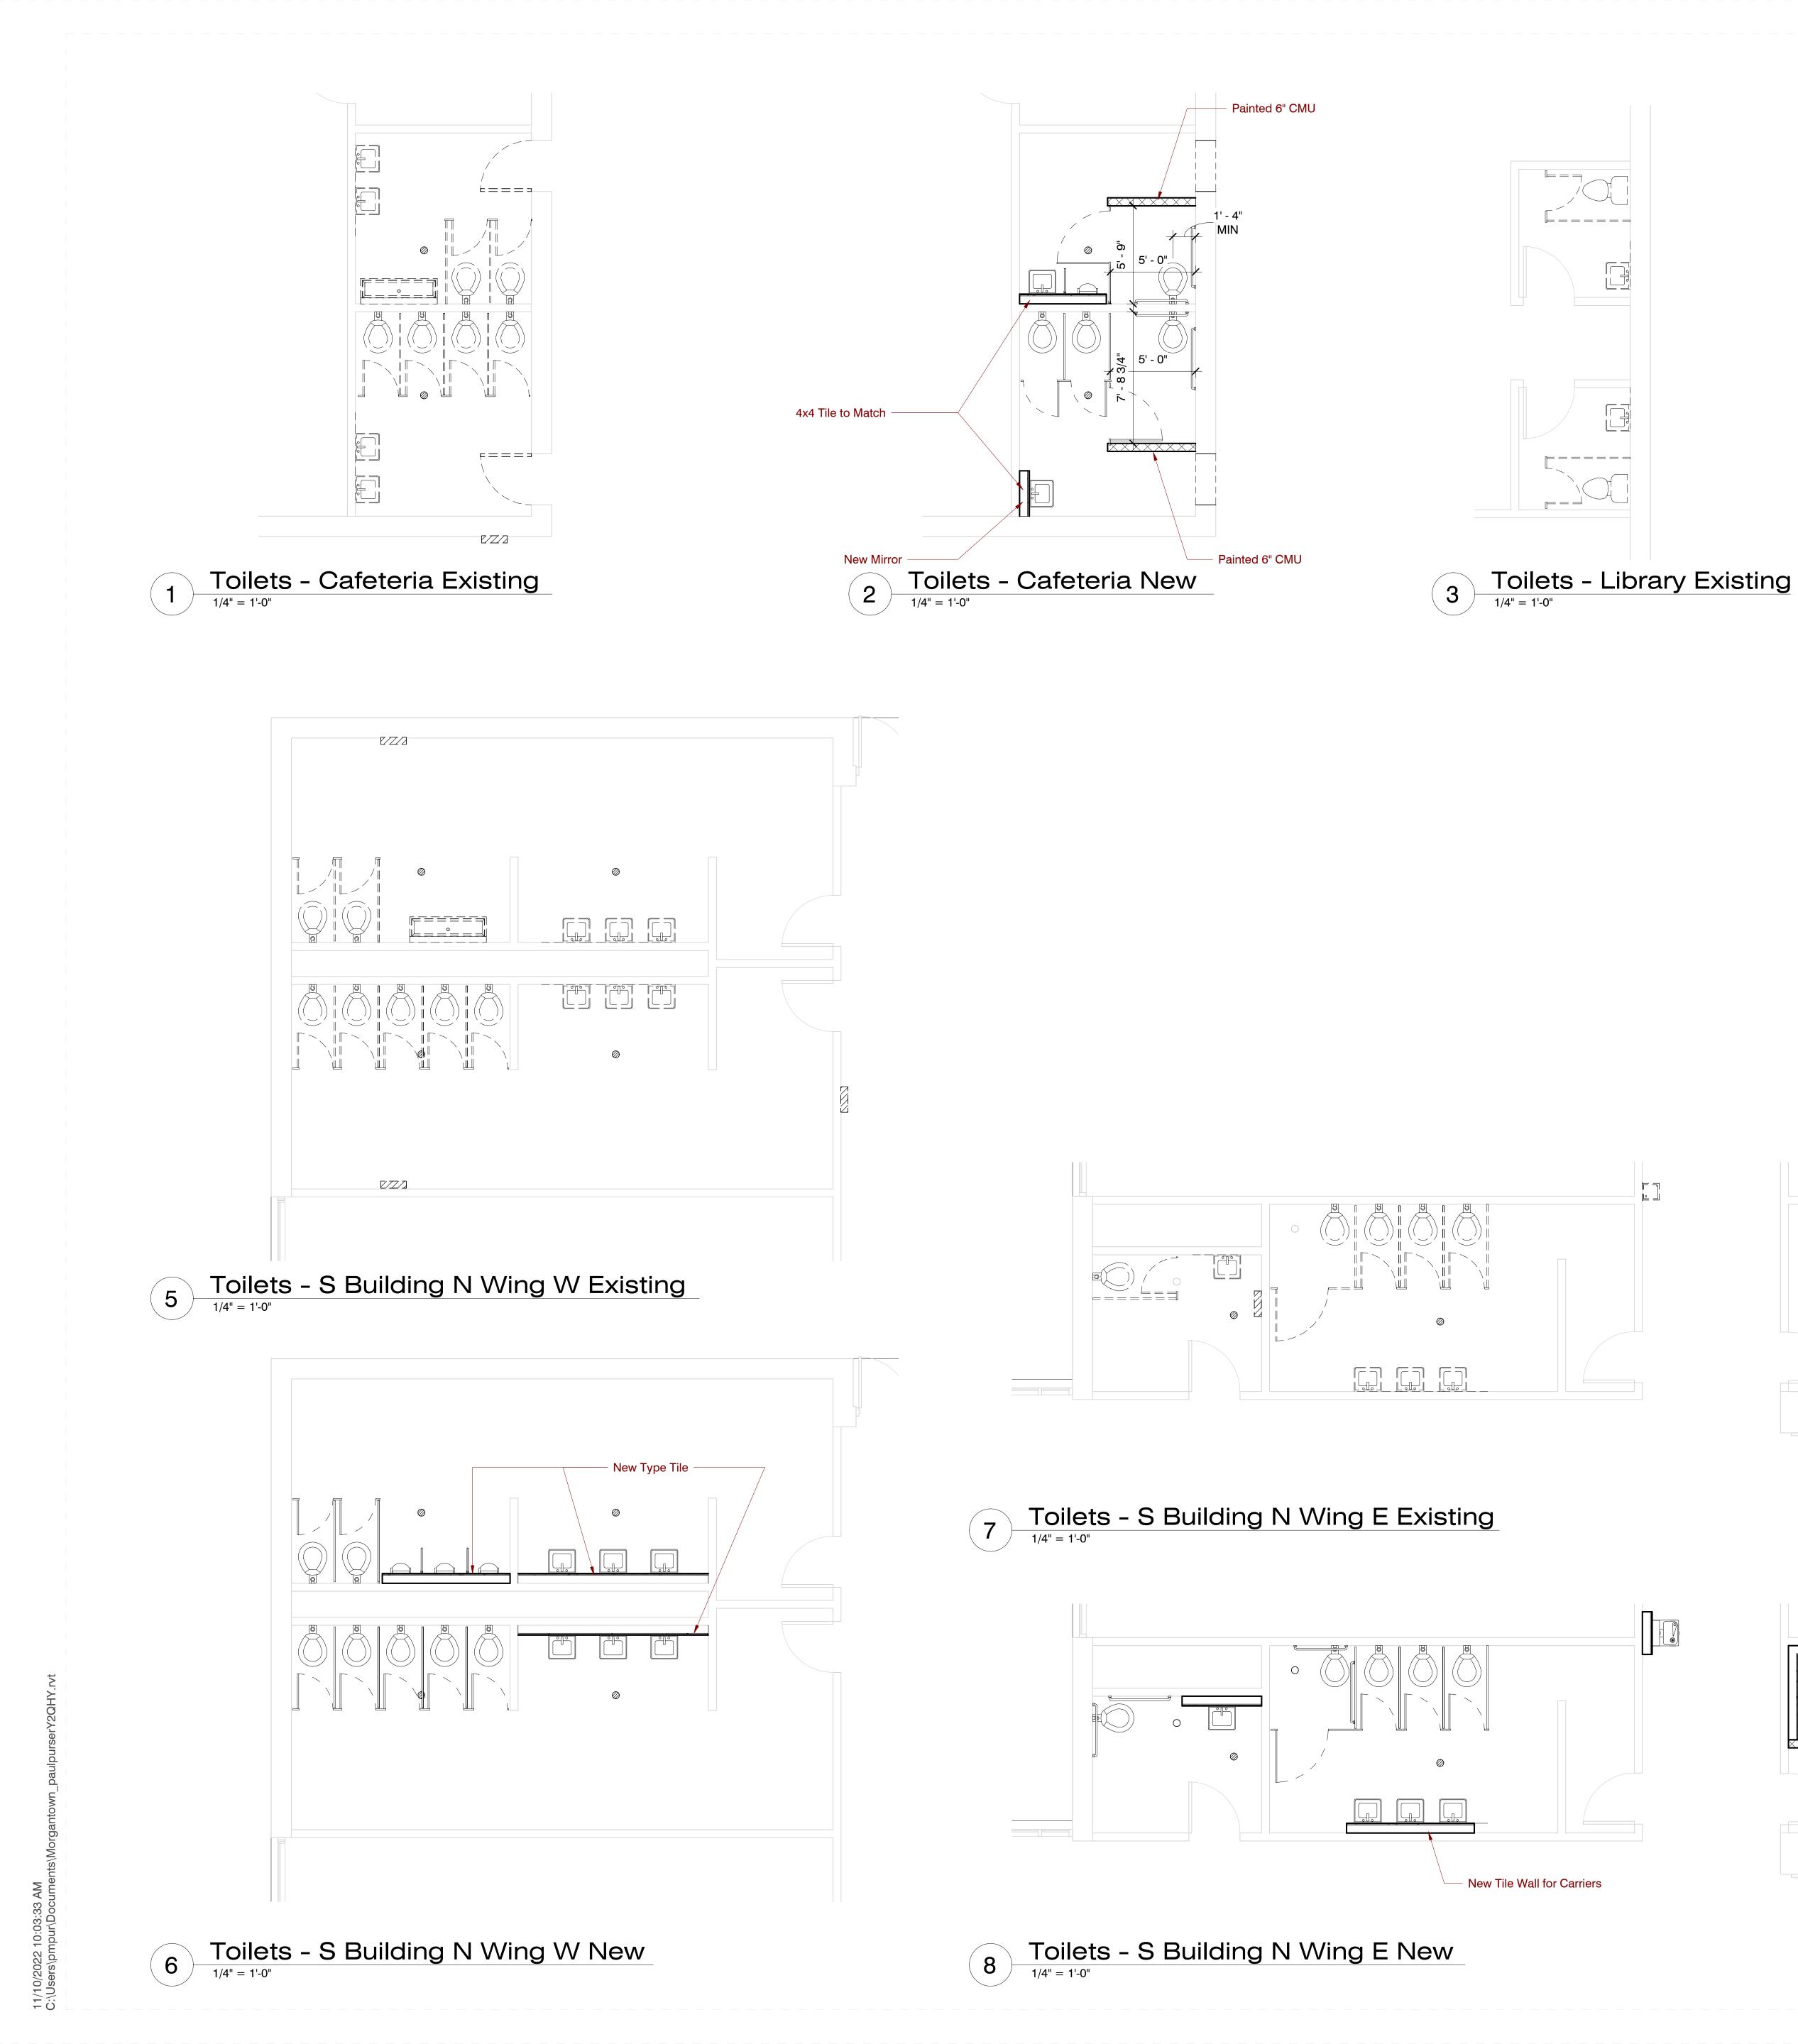


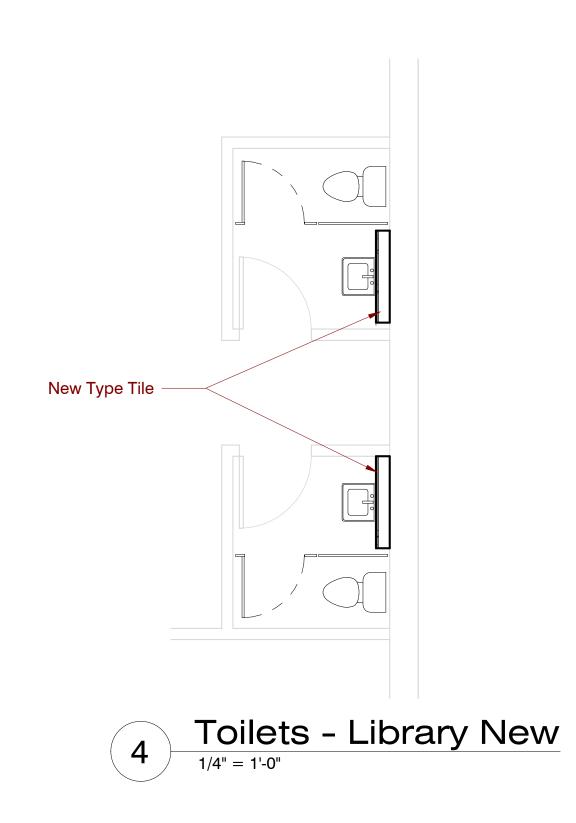


General Notes

- 1. Owner has right of refusal for all demo work. If not retained,
- GC to be responsible for disposal.
 2. Verify all existing conditions. Notify architect of any discrepancies between the existing conditions and these documents. The Contractor is to consider the additional work required by any discrepancies to be included in this
- Contract. 3. Burying or Burning of materials will not be permitted on site
- Repair any damage caused to building construction identified to remain.
- Refer to other discipline drawings for additional demolition information as noted.
- 6. Schedule with the Owner any demolition that involves exposing to the weather the interior portions of building to remain. This work is to be performed during good, dry weather or temporary waterproof barrier walls shall be constructed at all occurrences where the demolition exposes weather to the interior of portions of buildings to remain.
- 7. Existing loose school property to be the responsibility of the school district, removal of property by owner to be coordinated between the contractor and school district.
- Where areas are removed or altered, patch, repair, & paint to match adjacent surface material and finish.
 Where areas are removed or altered, patch, repair, & paint
- 9. Where new wall hung fixtures are installed, install new carriers for fixtures as well as a new 6" metal stud wall with tile at all exposed faces for 18" from center of fixture to edge of wall or into perpendicular abutting wall at either side OR as indicated on drawing.
- 10. Where fixtures are indicated to be replaced, include new finish plumbing and standard accessories including pipe insulation, faucets, flush valves, sealant, etc.
- Where new existing pipe is abandoned; cap pipe and paint to matching adjacement color.
 Install new grab bars at all ADA & AMB toilets
- 13. Install moisture resistant back board at all new tile.
- 14. Clean and reseal grout at floor tile.

Specific Notes

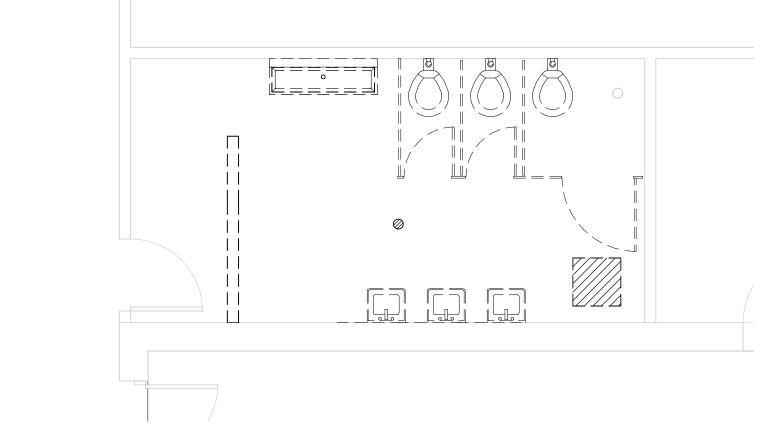

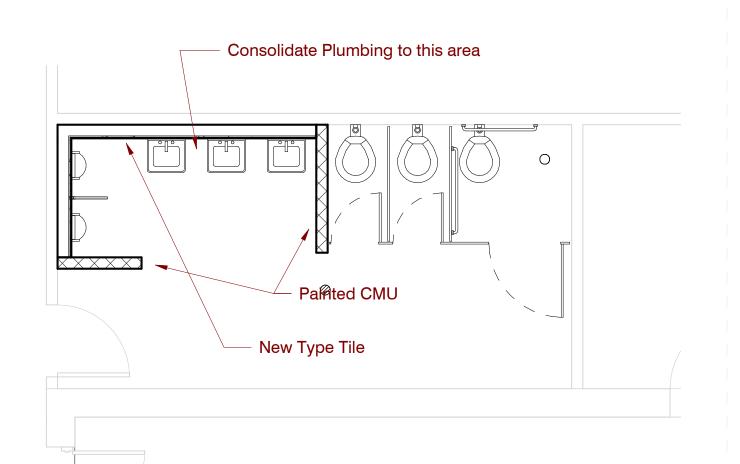

Add Alternate #1


- 1. Paint Toilet Room Interiors (previously painted surfaces,
- walls and Ceilings).2. Refinish Toilet Room Doors (all faces).
- Install new hardware at toilet room doors.


Deduct Alternate #2

1. Replace all new CMU Block walls with Plastic Toilet partitons.

Deduct Alternate #3

- 1. Make all new Metal Stud walls intended to conceal carriers partial height:
- A. 3'-6" at Lavatories B. 4'-6" at Urinals
- C. Cap All partial height walls with cast concrete toppers measuring 1-1/4" in thickness for full length of walls in section measuring a MIN of 4'-0" in length. Grout joints and seal to wall with mastic.

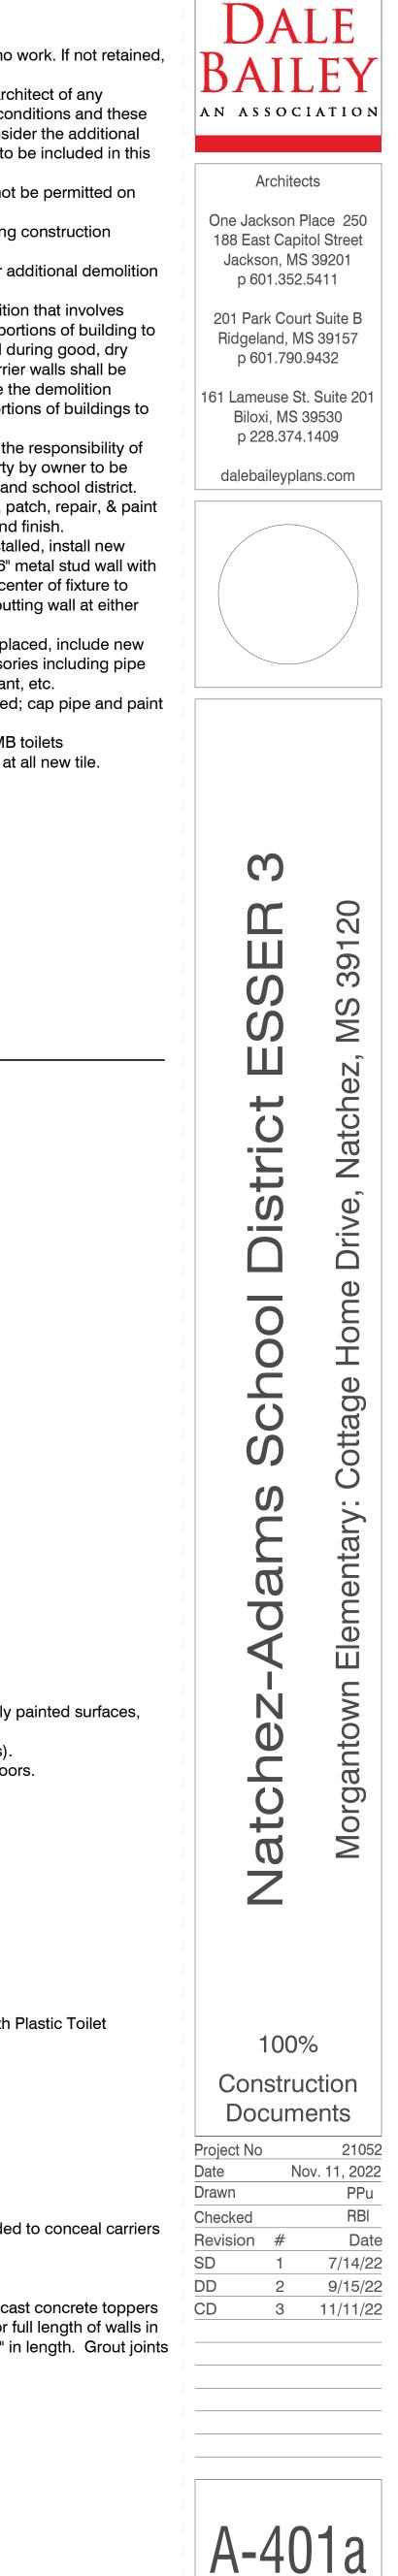

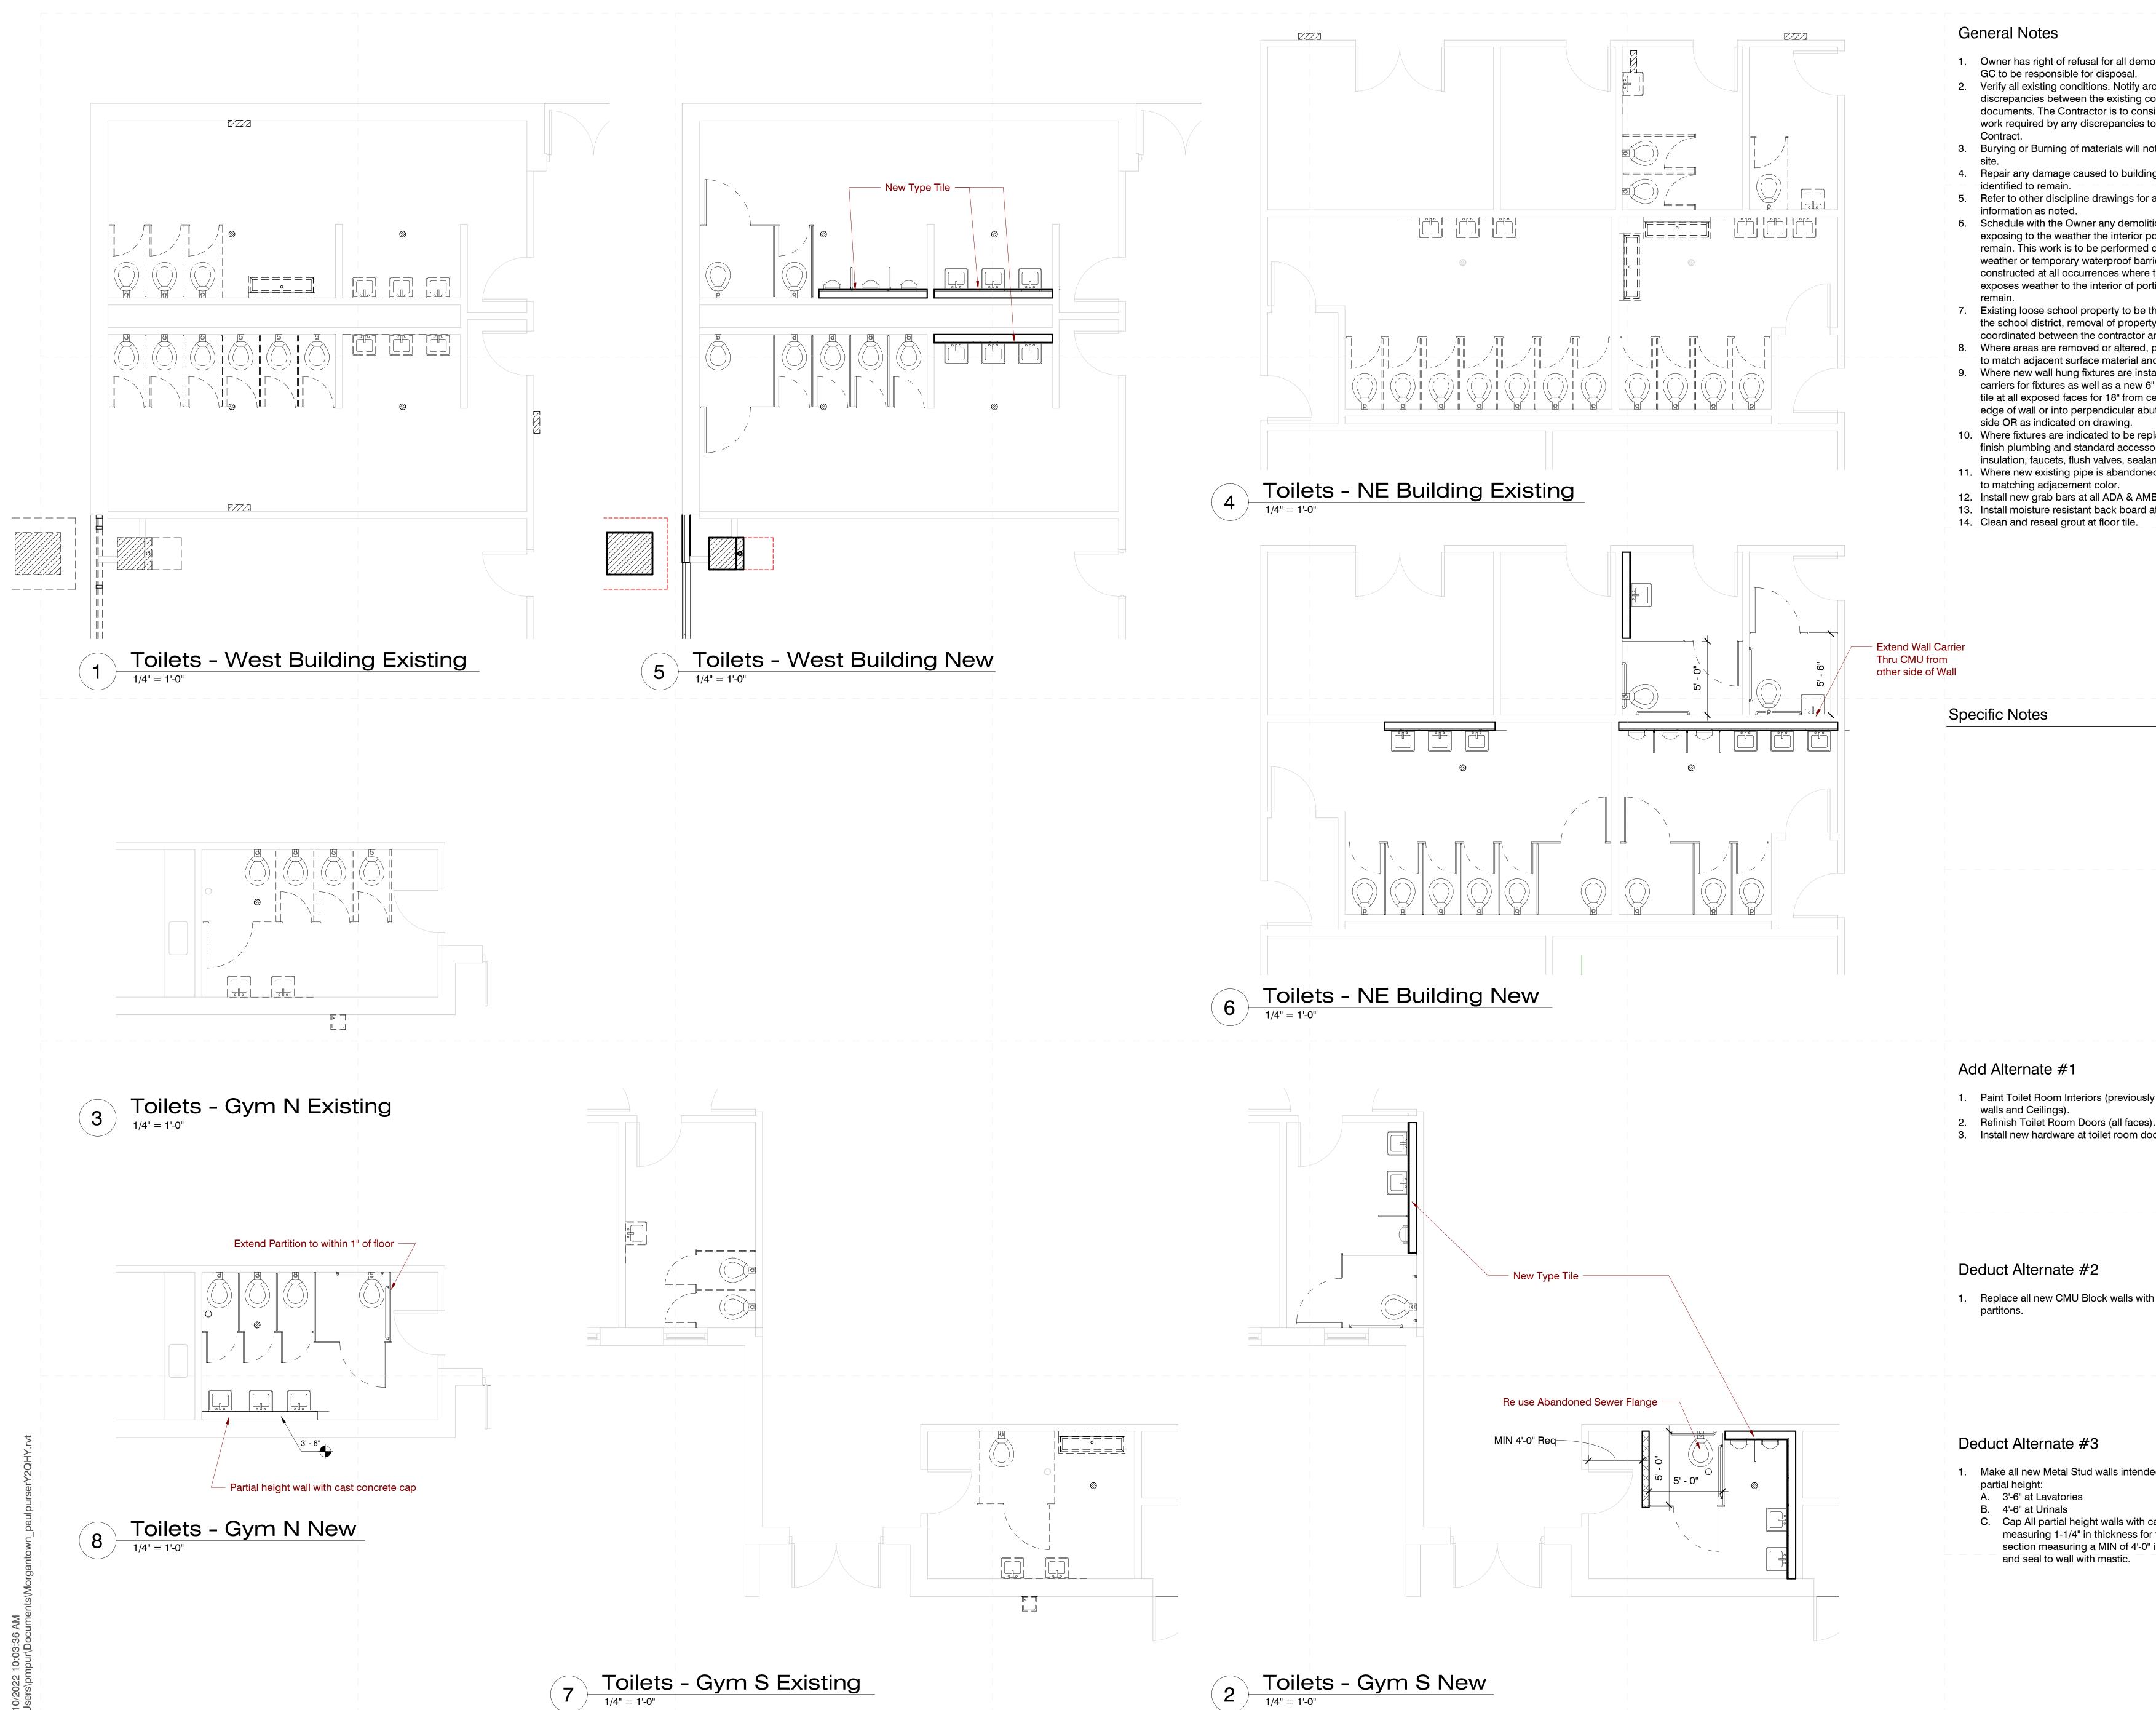


11/1 C:\L

no work. If not retained, architect of any conditions and these hsider the additional to be included in this not be permitted on ng construction r additional demolition ition that involves portions of building to d during good, dry rrier walls shall be e the demolition ortions of buildings to the responsibility of rty by owner to be and school district. , patch, repair, & paint and finish. stalled, install new 6" metal stud wall with center of fixture to putting wall at either placed, include new sories including pipe ant, etc. d to include new sories including pipe ant, etc. d to include new sories including pipe ant, etc.	DAI BAIL AN ASSOCI AN ASSOCI Architec One Jackson Pl 188 East Capite Jackson, MS p 601.352.5 201 Park Court Ridgeland, MS p 601.790.5 161 Lameuse St. Biloxi, MS 3 p 228.374.7 dalebaileyplar	EY ATION ts lace 250 ol Street 39201 5411 t Suite B 5 39157 9432 Suite 201 9530 1409
bly painted surfaces,	Natchez-Adams School District ESSER 3	Morgantown Elementary: Cottage Home Drive, Natchez, MS 39120
th Plastic Toilet		
ded to conceal carriers cast concrete toppers or full length of walls in " in length. Grout joints	100% Construct Docume Project No Date No Drawn Checked Revision # SD 1 DD 2 CD 3	ction
	A-40	

Enlarged Bathroom Plans



Front of School

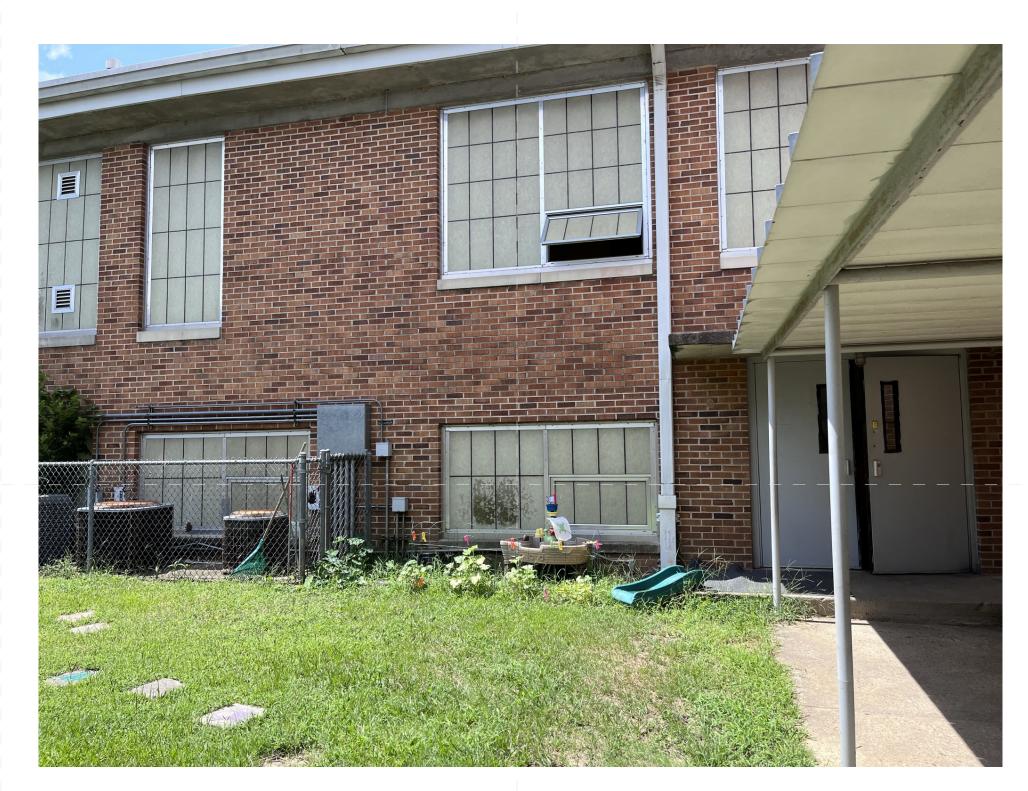



Entry Double Doors to be Replaced

Typical Double Doors to be Replaced




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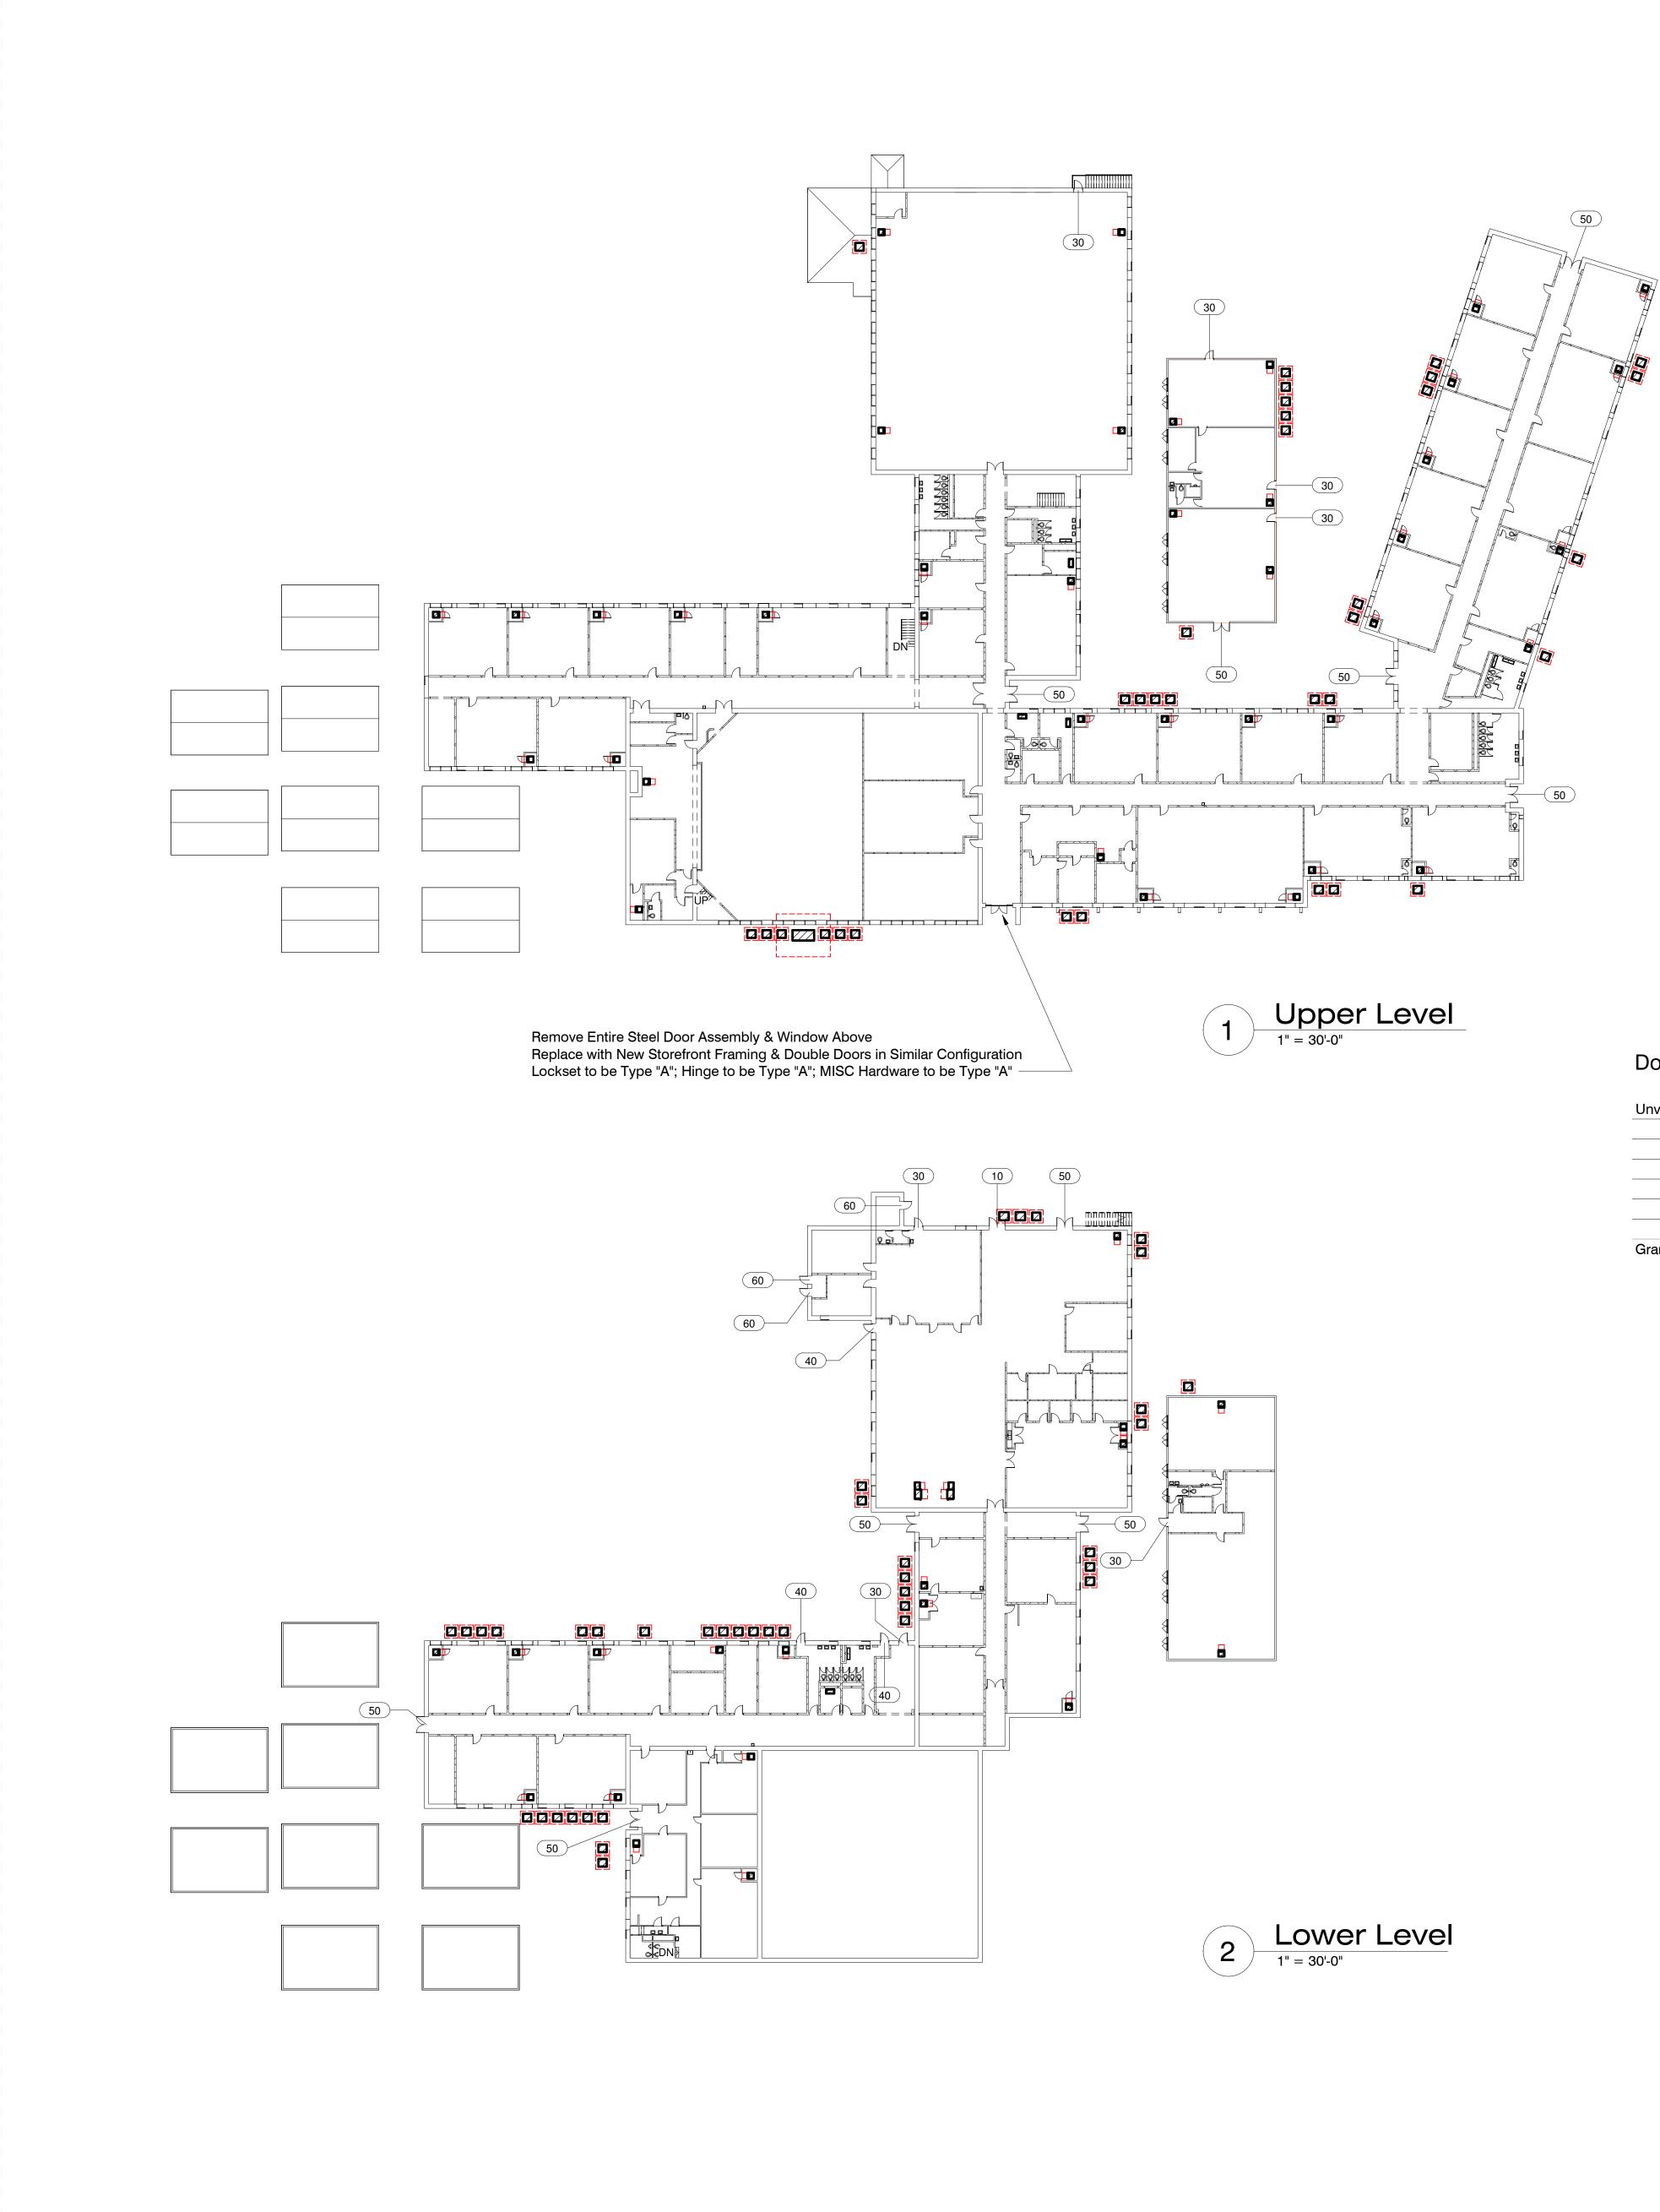


3 ESSER MS 39120 Dr., Natchez, District 170 Sgt Prentiss School dams McLaurin Elementary: Natchez 100%

Construction Documents

Project No		21052
Date		July 14, 2022
Drawn		PPu
Checked		RBI
Revision	#	Date
SD	1	7/14/22
DD	2	9/15/22
CD	3	11/11/22



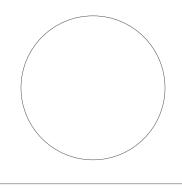

Door Schedule - Counts

Unverified Width	Matl	Туре	Jamb Material
6'-0"	Steel (Painted)	10	Steel
3'-0"	Steel (Painted)	30	Steel
3'-0"	Steel (Painted)	40	Steel
6'-0"	Steel (Painted)	50	Steel
3'-0"	Steel (Painted)	60	Steel
Grand total: 24			

All glazing shall insulated

Full Narrow Lite (8"x60") Steel Steel None С Α

Glz

None

Full Narrow Lite (8"x60")

None

Repair all steel jambs with exterior rated putty compound

Locket Types (all locksets to be mortised style if applicable)

Lockset Type Hinge Type MISC Hardware Type

Α

Α

Α

Α

- A. Panic Hardware with Lever Exterior B. Double Keyed Lock with Pull & Push Hardware
- C. Panic Hardware with no Exterior Hardware

D. Storage Function Lever w Deabolt

D

Α

Α

D

Hinge Types A. Full Height Tamper Proof Geared Hinge

MISC Hardware Types A. Doors without Exposure

- a. New Threshold (embed in sealant)
- b. Brush Door Sweep
- c. Jamb and Head Gasketing
- d. Door Closer
- e. Door Stop (wall or floor depending on location) B. Doors with Exposure
- a. New Threshold (embed in sealant)
- b. Brush Door Sweep
- c. Jamb and Head Gasketing
- d. Door Closer
- e. Kick Down Holder
- f. Door Stop (wall or floor depending on location) g. Aluminum Drip at Door Head

Scope Summary

Notes

Verify All Dimensions; Provide Full Vent @ Panel


Verify All Dimensions

Verify All Dimensions

Verify All Dimensions

Verify All Dimensions; Provide Full Vent @ Panel

- New Mechaincal Units as noted in Mechanical drawings
- Repair Exterior doors for weather tightness 1. Replace Door Panels with new 2. Install new hardware including locksets &
- Continuous hinges as well as all weatherstripping 3. Install new drip at head of all doors exposed to
- weather 4. Paint all jambs
- Renovate toilet rooms as shown in architectural plans and mechanical plans
- 1. Change out all fixtures
- 2. Install new touchless flush valves 3. Install new touchless facuets
- 4. install new toilet partitions
- 5. Replace Water Fountains with New Bottle Filling Stations
- A. Provide new 6" Metal Stud Wall with 5/8" concrete backer board & tile behind all water fountains measuring 3' wide and 7' tall

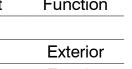

Count Function

1	Exterior
7	Exterior
3	Exterior
10	Exterior
3	Exterior

3

Architect One Jackson Pl 188 East Capito Jackson, MS p 601.352.5 201 Park Court Ridgeland, MS p 601.790.9 161 Lameuse St. Biloxi, MS 3 p 228.374.1 dalebaileyplar	ace 250 ol Street 39201 5411 Suite B 3 39157 9432 Suite 201 9530 409
Natchez-Adams School District ESSER 3	McLaurin Elementary: 170 Sgt Prentiss Dr., Natchez, MS 39120
100% Construct Docume Project No Date Ju Drawn Checked Revision # SD 1 DD 2 CD 3	ction
Δ_10	1h

DALE

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AN ASSOCIATION



	All	School's	Specific	Notes
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22 42 00 002 New fixtures in this toilet room; coordinate with


mechanical 22 42 00 003 New touchless faucet at sink/cabinet; coordinate with mechanical


22 42 00 007 Install new fixture; coordinate with mechanical 22 47 13 002 Install single drinking fountain here with bottle filler attachment; coordinate with mechanical & electrical drawings

General Project Notes

- 1. Whereever fixture indicated to be replaced, include new finish plumbing and standard accessories including pipe insulation, faucets, flush valves, sealant, etc.
- 2. Notify Architect in writing of any rough in plumbing that is not draining properly or supplying water as needed.
- 3. Accessories to be replaced only as noted on floor plans.



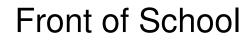

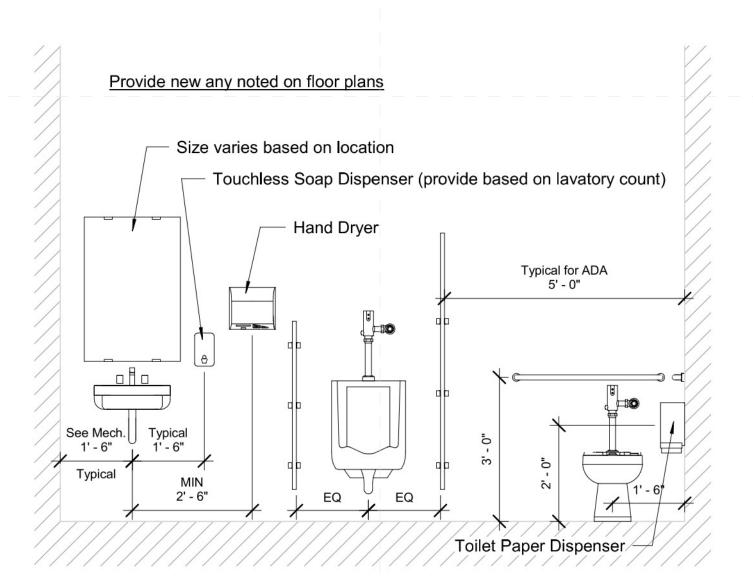

1 Typical Toilet Room Wall 1/2" = 1'-0"



Other Cabinet Lavs






Typical Urinal Style

Typical Toilet Style

Typical Toilet Lav Wall

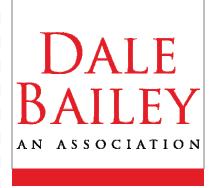


Architects

One Jackson Place 250 188 East Capitol Street Jackson, MS 39201 p 601.352.5411

201 Park Court Suite B Ridgeland, MS 39157 p 601.790.9432


161 Lameuse St. Suite 201 Biloxi, MS 39530 p 228.374.1409

dalebaileyplans.com

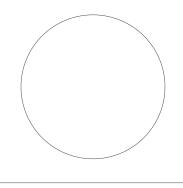



 \mathfrak{O} ESSER 39120 MS : Dr, Natchez, District Lewis School 161 West Elementary: dams Susie B. Natchez 100% Construction Documents 21052 Nov. 11, 2022 PPu Project No Date Drawn RBI Checked Date Revision # 3 10/21/22 DD 4 11/11/22 CD


G-000c General Sheet

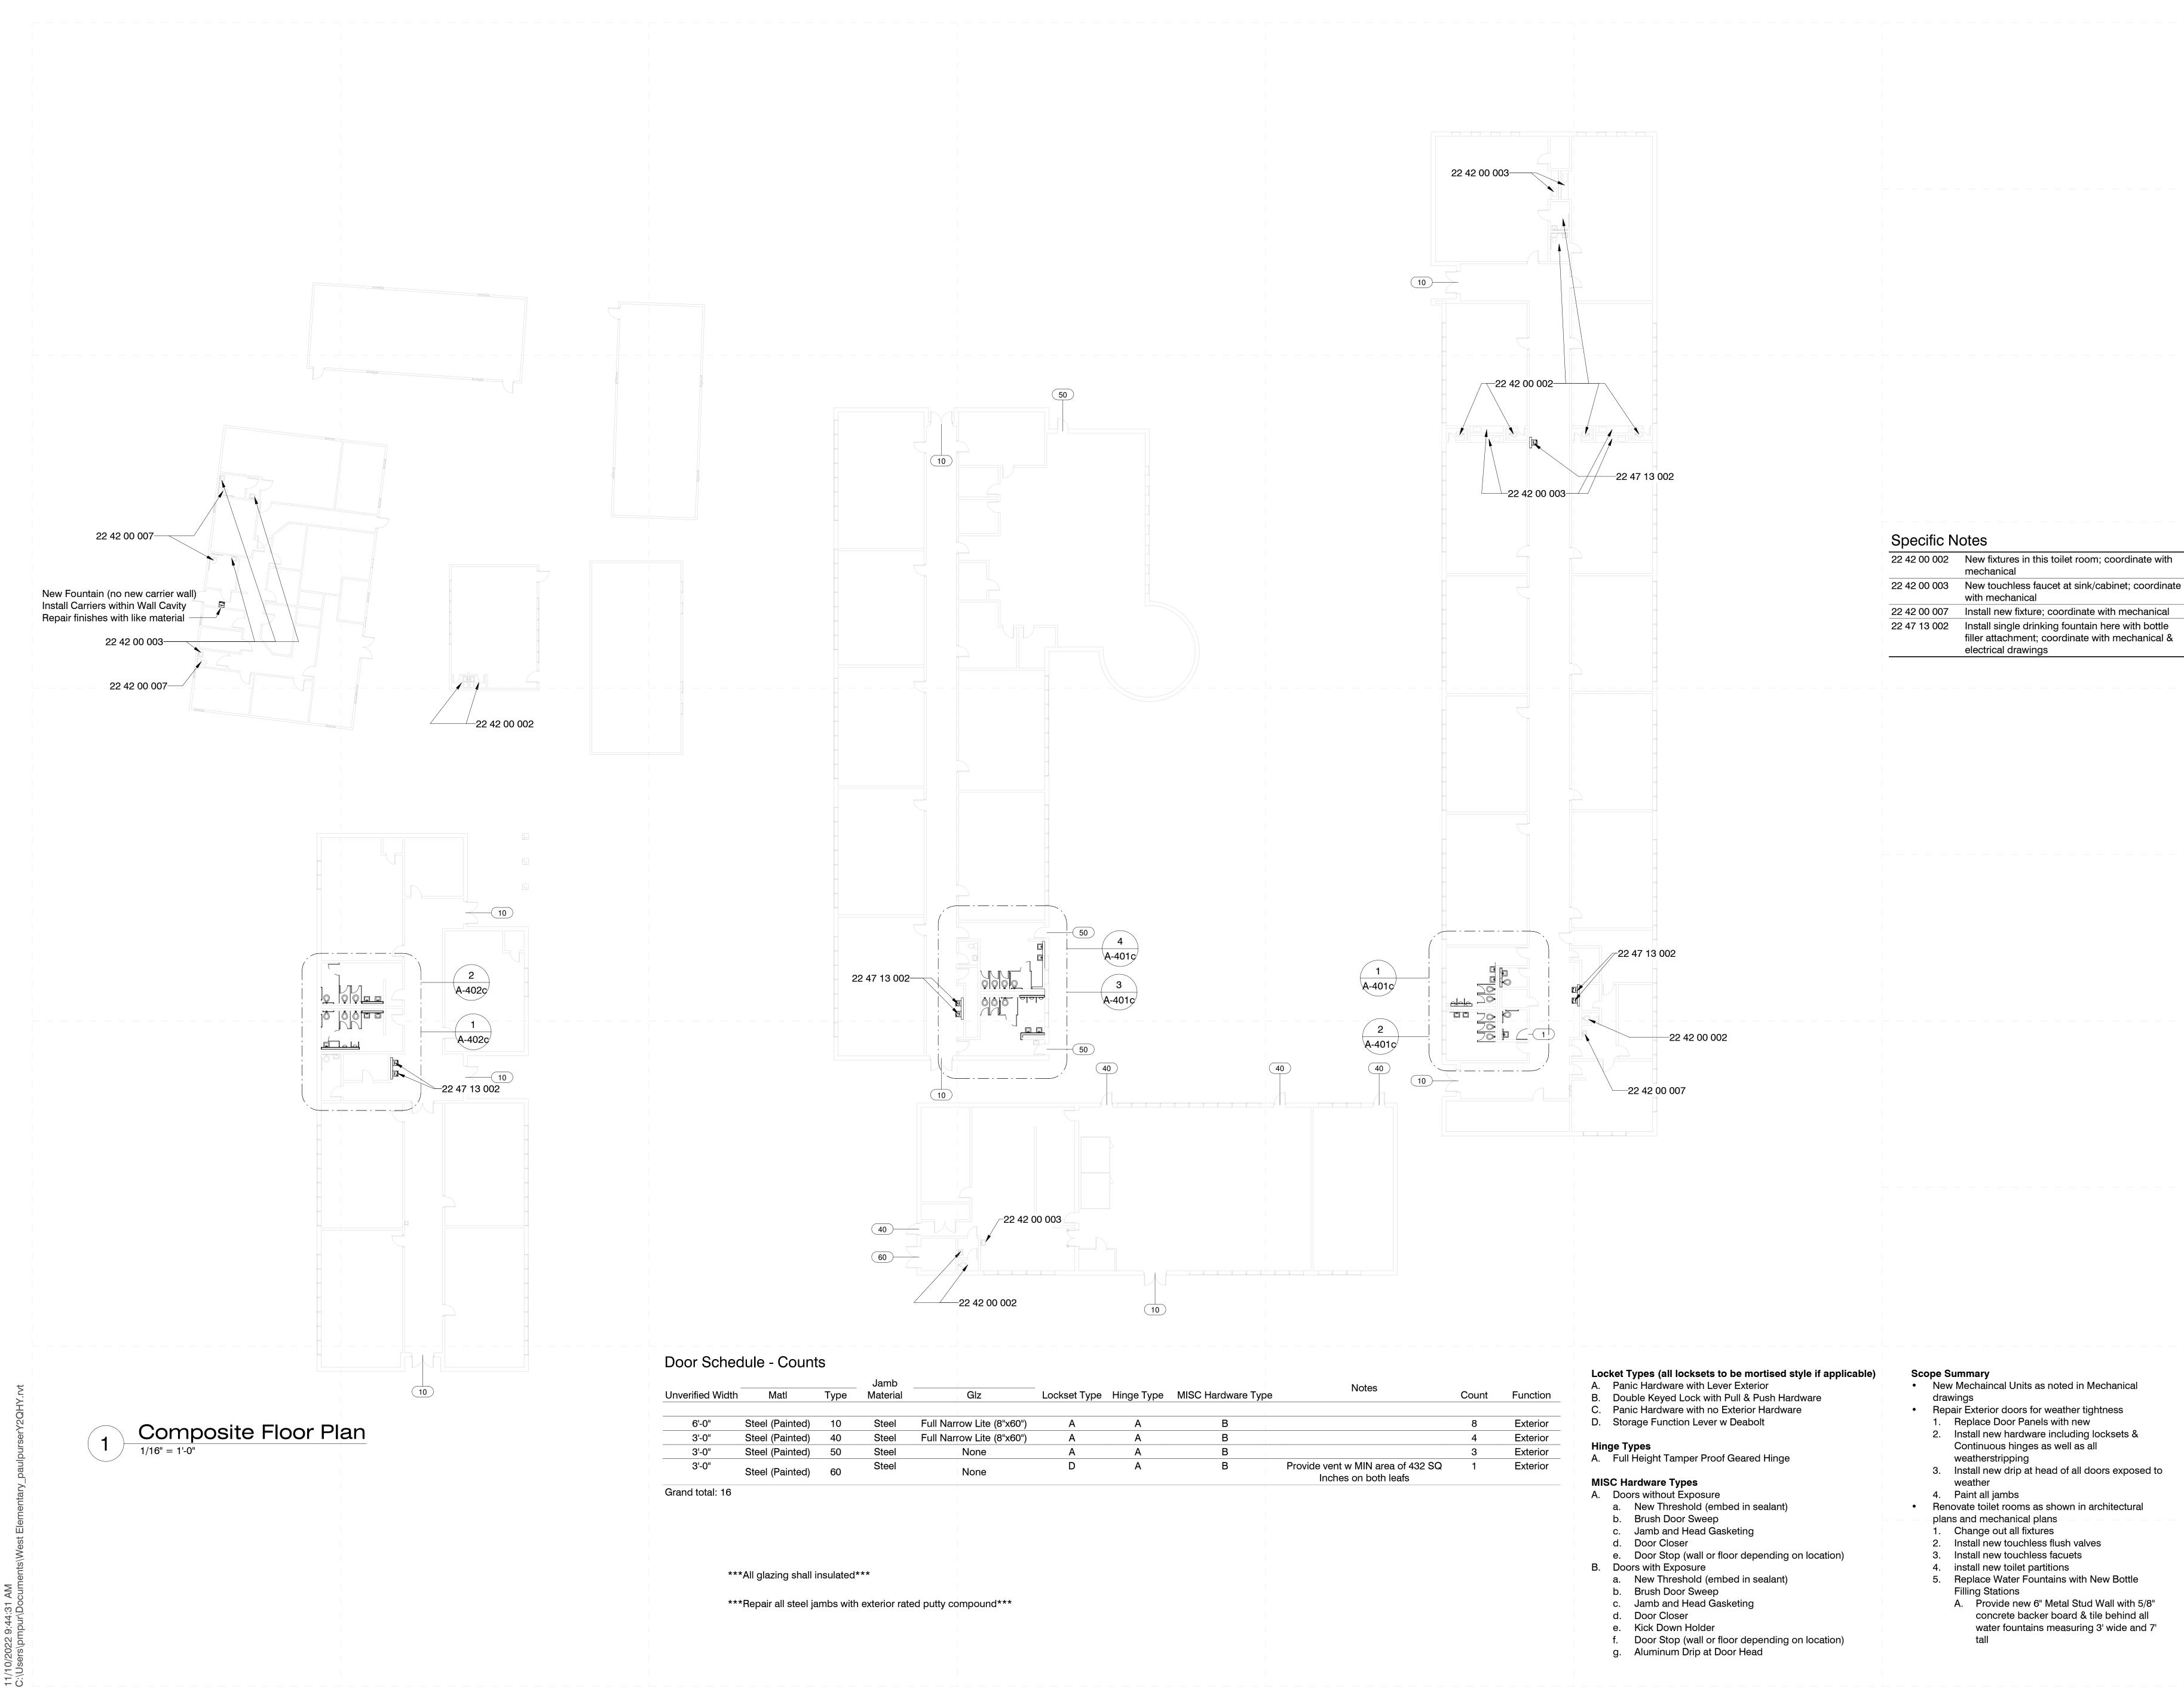


			Jamb		_			Note
Unverified Width	Matl	Туре	Material	Glz	Lockset Type	Hinge Type	MISC Hardware Type	NOLE
6'-0"	Steel (Painted)	10	Steel	Full Narrow Lite (8"x60")	A	А	В	
3'-0"	Steel (Painted)	40	Steel	Full Narrow Lite (8"x60")	А	А	В	
3'-0"	Steel (Painted)	50	Steel	None	А	А	В	
3'-0"	Steel (Painted)	60	Steel	None	D	А	В	Provide vent w MIN Inches on b

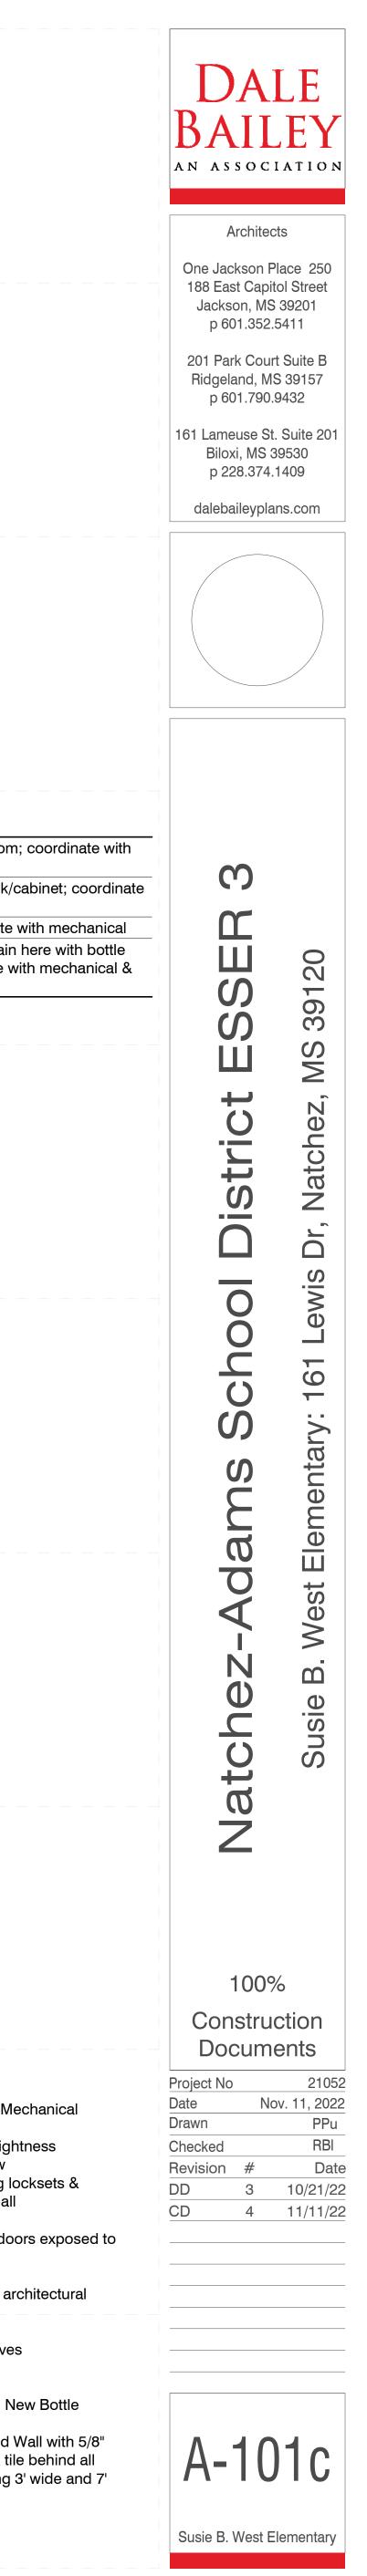

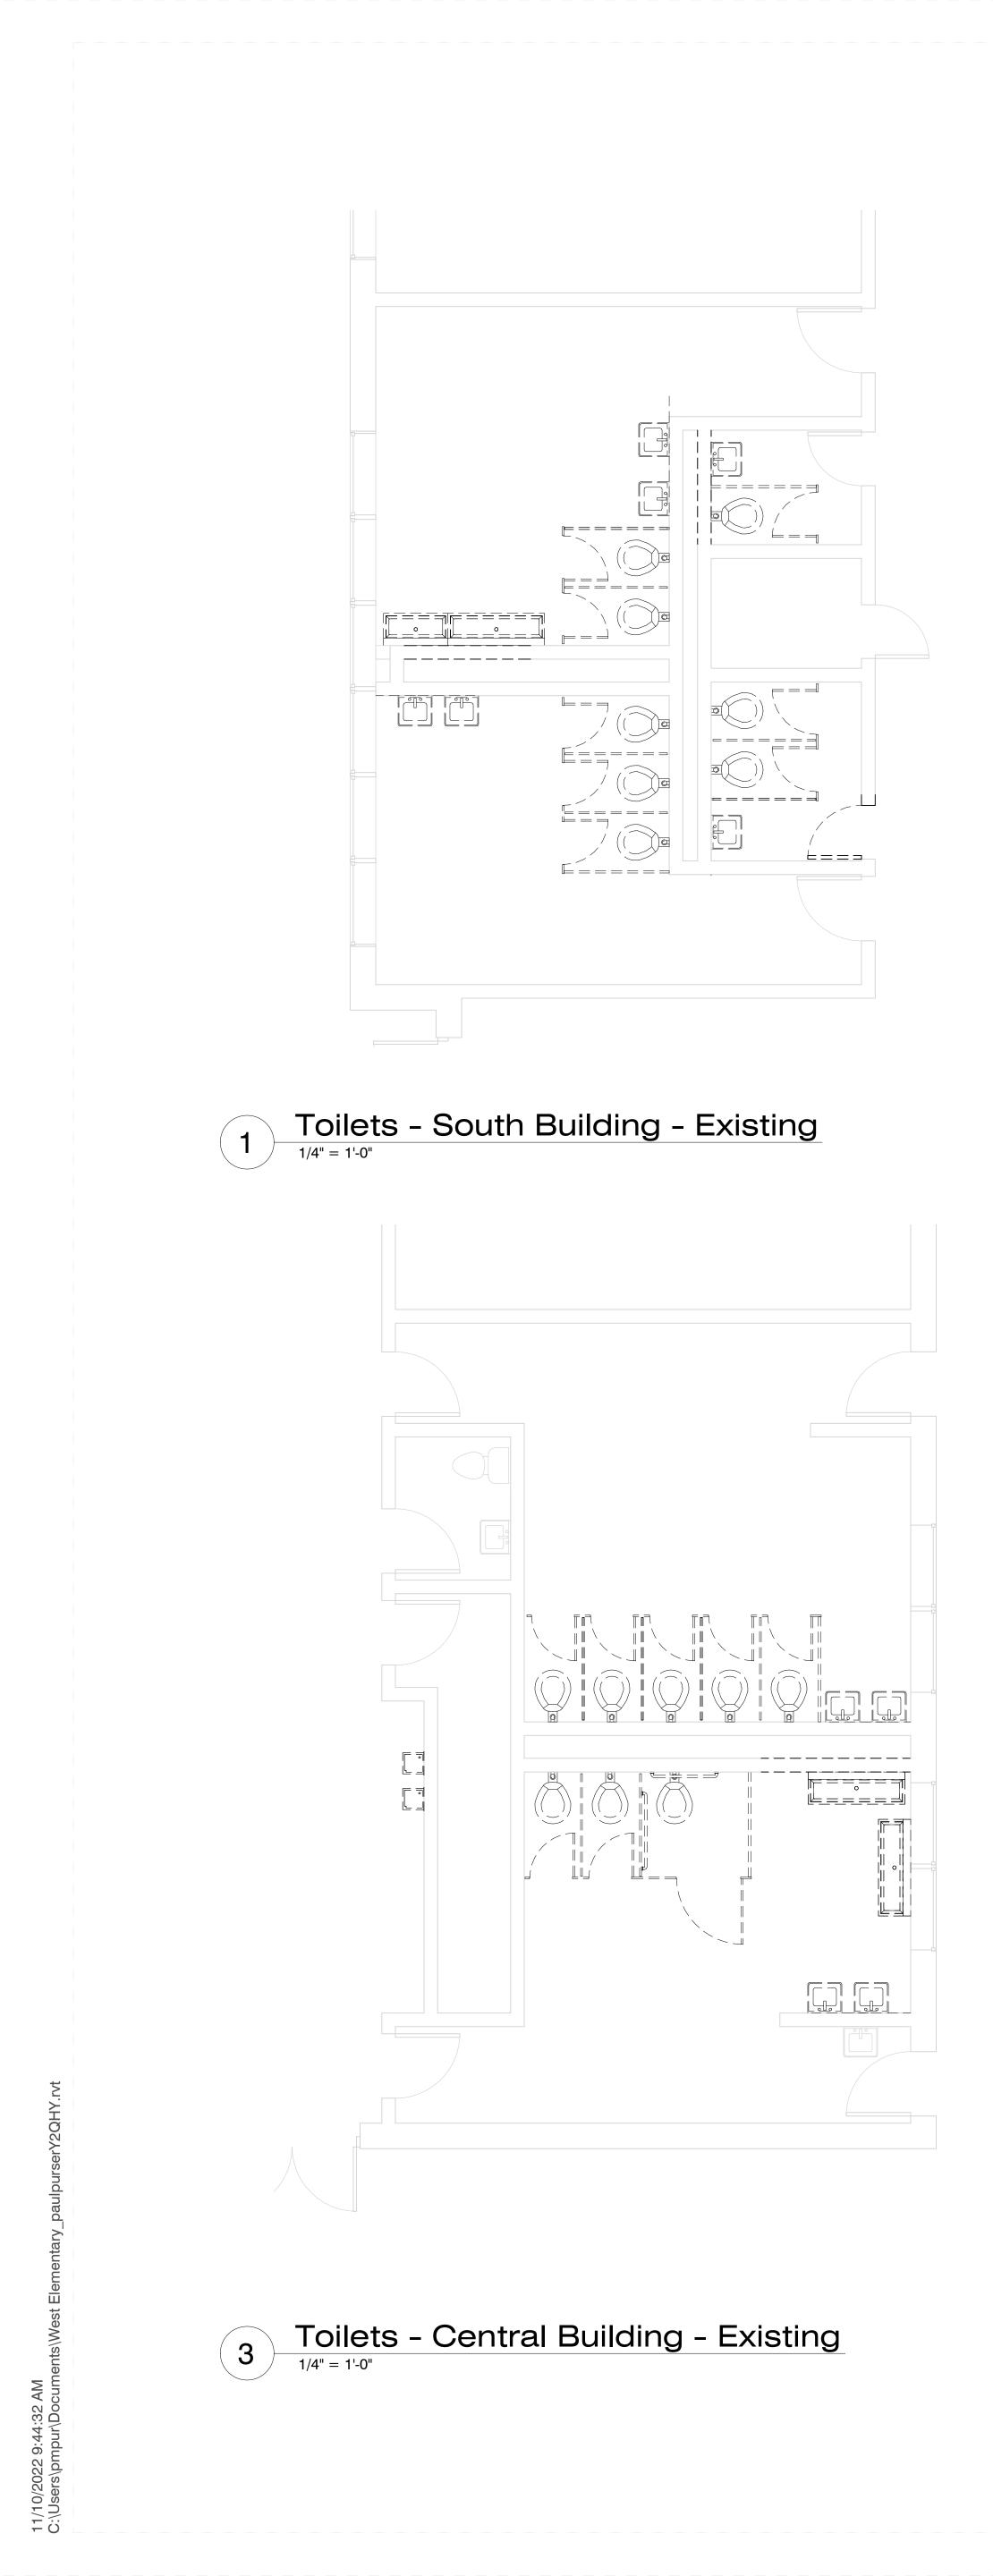

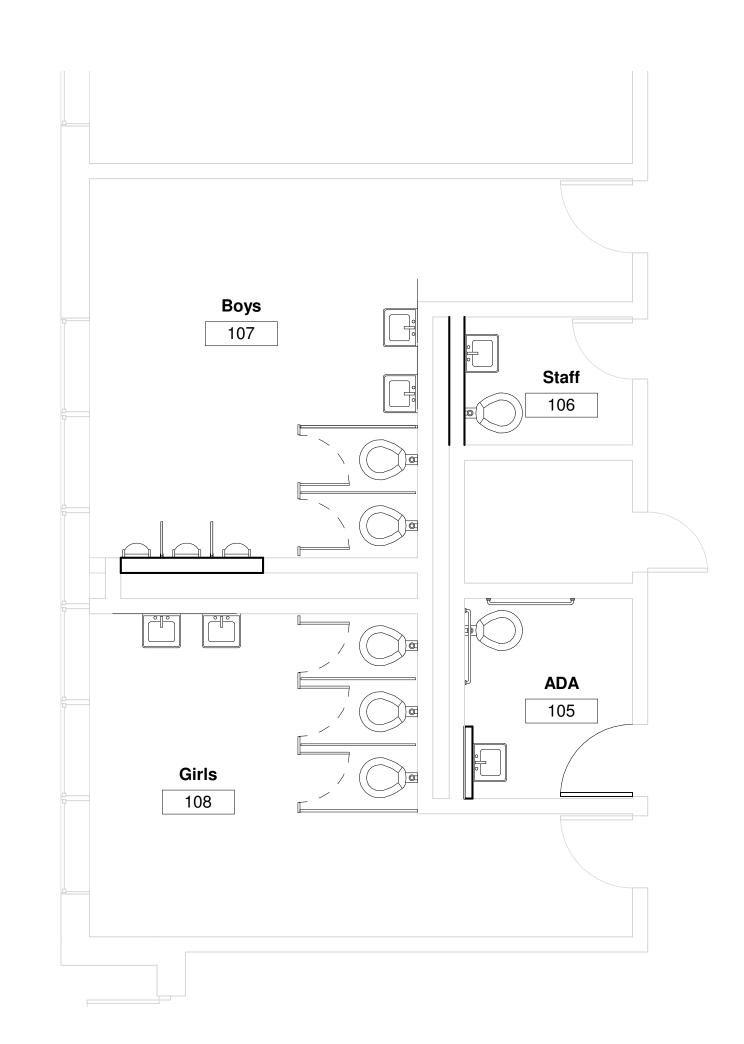

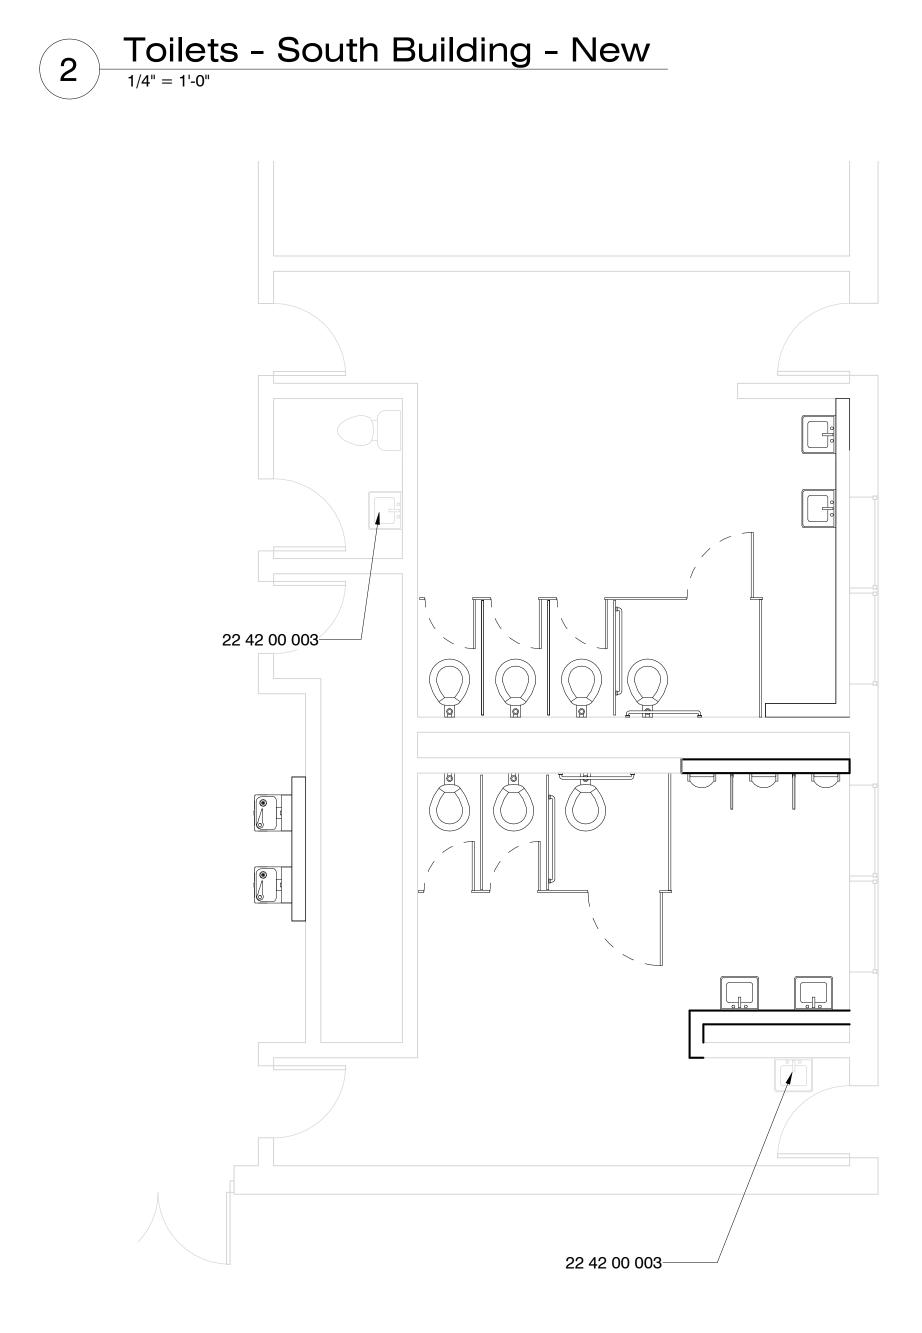



General Notes

- 1. Owner has right of refusal for all demo work. If not retained,
- GC to be responsible for disposal.
 2. Verify all existing conditions. Notify architect of any discrepancies between the existing conditions and these documents. The Contractor is to consider the additional work required by any discrepancies to be included in this
- Contract. 3. Burying or Burning of materials will not be permitted on
- Repair any damage caused to building construction identified to remain.
- 5. Refer to other discipline drawings for additional demolition information as noted.
- 6. Schedule with the Owner any demolition that involves exposing to the weather the interior portions of building to remain. This work is to be performed during good, dry weather or temporary waterproof barrier walls shall be constructed at all occurrences where the demolition exposes weather to the interior of portions of buildings to remain.
- 7. Existing loose school property to be the responsibility of the school district, removal of property by owner to be coordinated between the contractor and school district.
- 8. Where areas are removed or altered, patch, repair, & paint to match adjacent surface material and finish.
 9. Where now well hung fixtures are installed installed.
- Where new wall hung fixtures are installed, install new carriers for fixtures as well as a new 6" metal stud wall with tile at all exposed faces for 18" from center of fixture to edge of wall or into perpendicular abutting wall at either side OR as indicated on drawing.
- Where fixtures are indicated to be replaced, include new finish plumbing and standard accessories including pipe insulation, faucets, flush valves, sealant, etc.
- 11. Where new existing pipe is abandoned; cap pipe and paint to matching adjacement color.
 12. Install new such have stall ADA 2. AMD is its interval.
- 12. Install new grab bars at all ADA & AMB toilets 13. Install moisture resistant back board at all new tile.
- 14. Clean and reseal grout at floor tile.

Specific Notes

22 42 00 003	New touchless faucet at si
	with mechanical
-	

Add Alternate #1

- 1. Paint Toilet Room Interiors (previously painted surfaces,
- walls and Ceilings).2. Refinish Toilet Room Doors (all faces).
- 3. Install new hardware at toilet room doors.

Deduct Alternate #2


1. Replace all new CMU Block walls with Plastic Toilet partitons.


Deduct Alternate #3

- 1. Make all new Metal Stud walls intended to conceal carriers partial height:
- A. 3'-6" at Lavatories B. 4'-6" at Urinals
- C. Cap All partial height walls with cast concrete toppers measuring 1-1/4" in thickness for full length of walls in section measuring a MIN of 4'-0" in length. Grout joints and seal to wall with mastic.



Enlarged Bathroom Plans

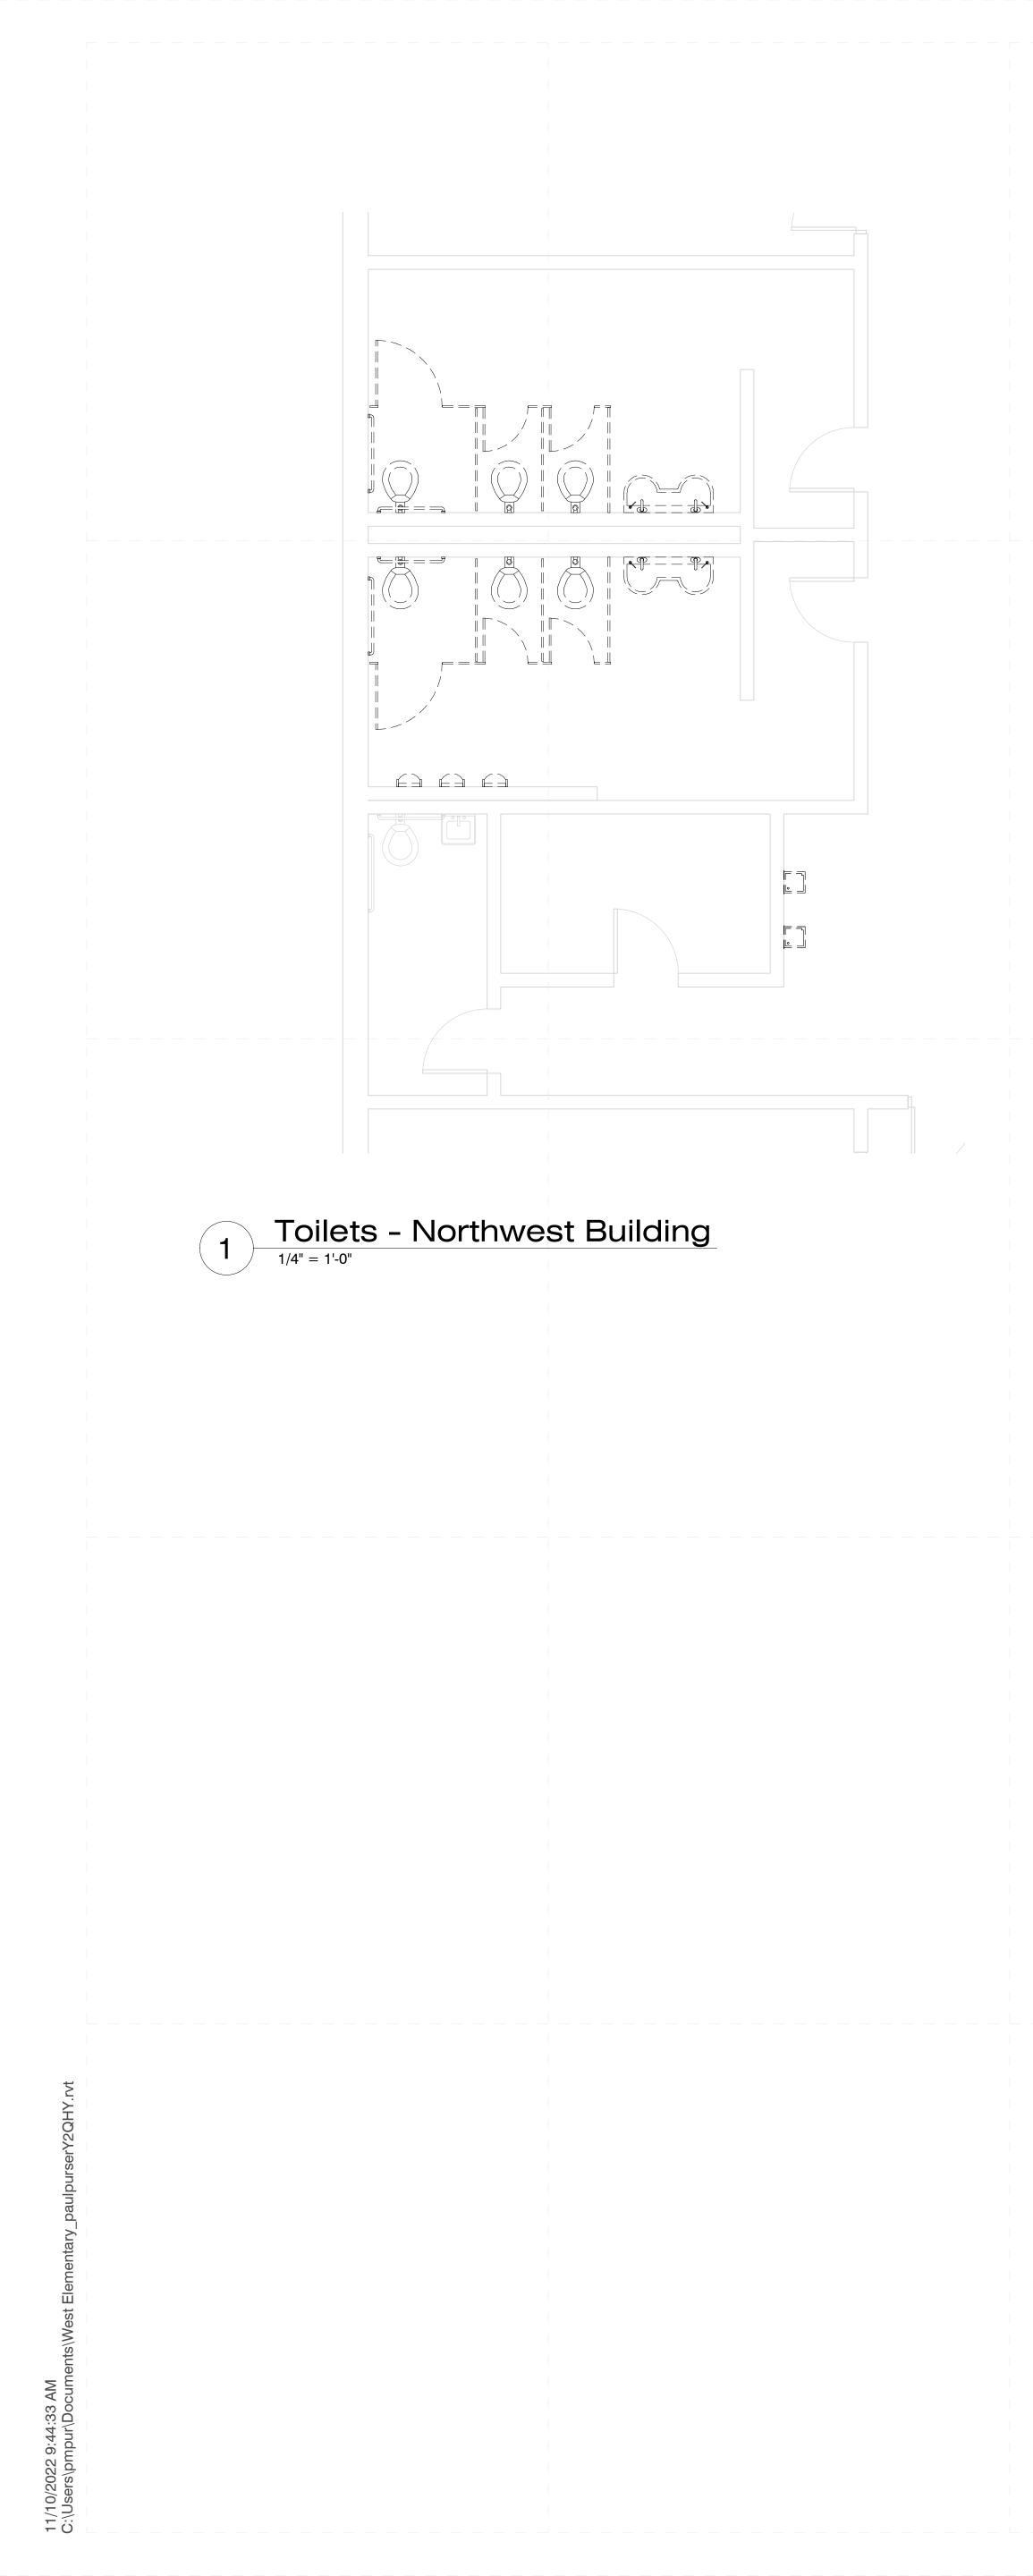

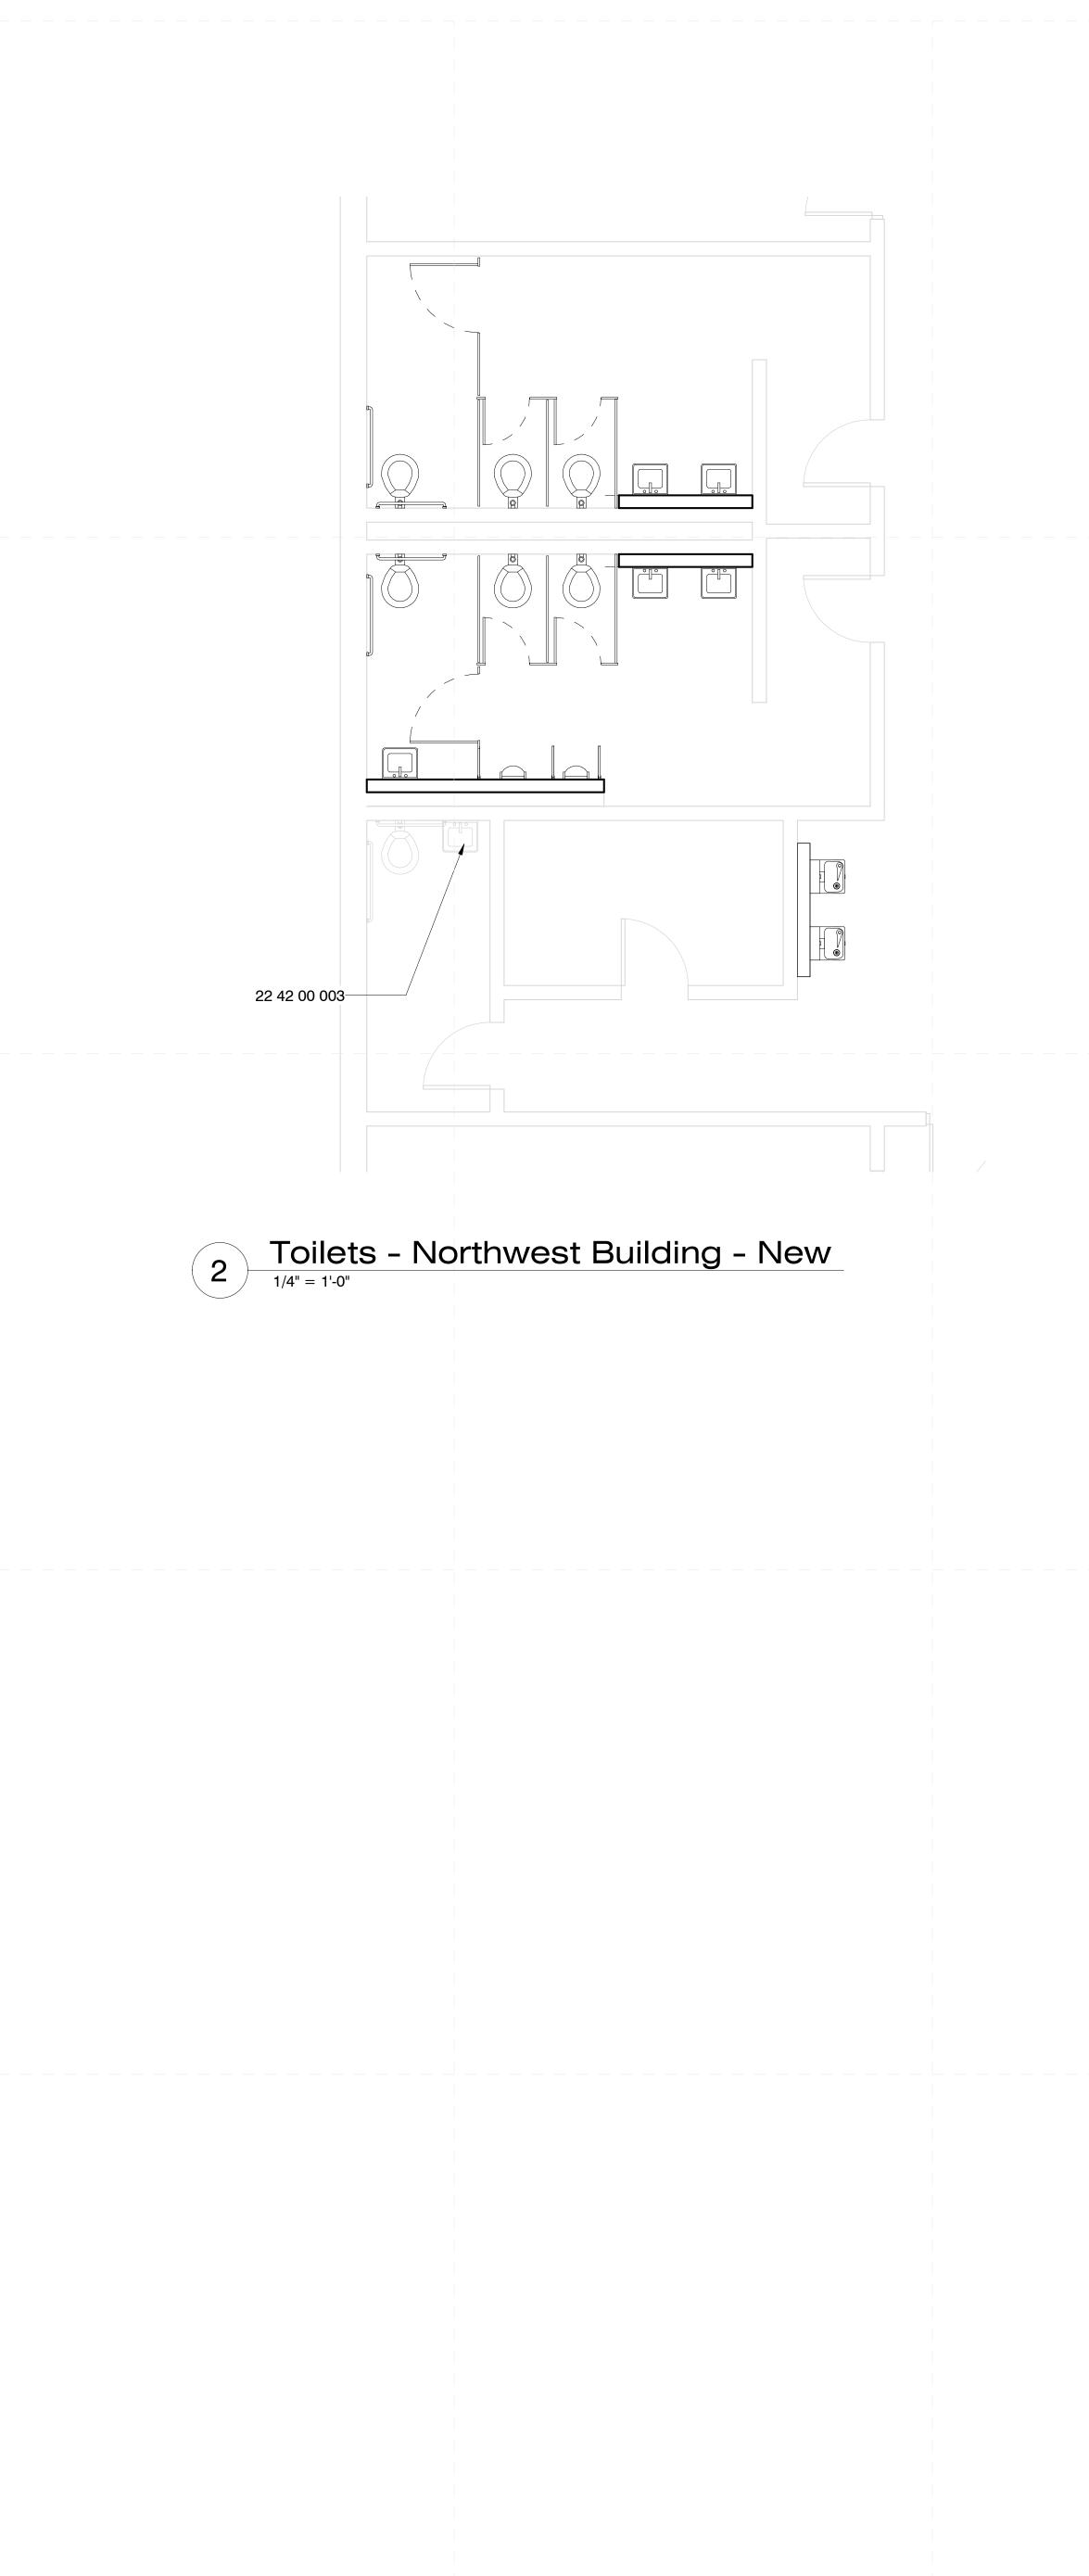

General Notes

- 1. Owner has right of refusal for all demo work. If not retained, GC to be responsible for disposal.
- Verify all existing conditions. Notify architect of any discrepancies between the existing conditions and these documents. The Contractor is to consider the additional work required by any discrepancies to be included in this Contract.
- Burying or Burning of materials will not be permitted on site.
- 4. Repair any damage caused to building construction identified to remain.
- 5. Refer to other discipline drawings for additional demolition information as noted.
- 6. Schedule with the Owner any demolition that involves exposing to the weather the interior portions of building to remain. This work is to be performed during good, dry weather or temporary waterproof barrier walls shall be constructed at all occurrences where the demolition exposes weather to the interior of portions of buildings to remain.
- Existing loose school property to be the responsibility of the school district, removal of property by owner to be coordinated between the contractor and school district.
 Where areas are removed or altered, patch, repair, & paint
- to match adjacent surface material and finish. 9. Where new wall hung fixtures are installed, install new
- carriers for fixtures as well as a new 6" metal stud wall with tile at all exposed faces for 18" from center of fixture to edge of wall or into perpendicular abutting wall at either side OR as indicated on drawing.
- Where fixtures are indicated to be replaced, include new finish plumbing and standard accessories including pipe insulation, faucets, flush valves, sealant, etc.
 Where new existing pipe is abandoned; cap pipe and paint
- to matching adjacement color. 12. Install new grab bars at all ADA & AMB toilets 13. Install moisture resistant back board at all new tile.
- 13. Install moisture resistant back board 14. Clean and reseal grout at floor tile.

Specific Notes

2 42 00 003	New touchless faucet at sink/
	with mechanical

Add Alternate #1

- 1. Paint Toilet Room Interiors (previously painted surfaces,
- walls and Ceilings). 2. Refinish Toilet Room Doors (all faces).
- Install new hardware at toilet room doors.

Deduct Alternate #2

1. Replace all new CMU Block walls with Plastic Toilet partitons.

Deduct Alternate #3

- 1. Make all new Metal Stud walls intended to conceal carriers partial height:
- A. 3'-6" at Lavatories B. 4'-6" at Urinals
- C. Cap All partial height walls with cast concrete toppers measuring 1-1/4" in thickness for full length of walls in section measuring a MIN of 4'-0" in length. Grout joints and seal to wall with mastic.

